

PROJECT NO.		YI	EAR	SHEET NO.	
790	022-422	21-04	1	994	
			REV	/ISION	S
NO	DATE	BY	BRIEF DESCRIPTION		BRIEF DESCRIPTION
Δ	6/2/94	πLJ	CHG. RI	V DATES	ELIM UPLIFT RESTRAINTS AT BENTS
			AND SET	SMIC REST	RAINTS AT BENTS C,D H & J
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SCOPE OF WORK

- (1) RESET EXISTING TILTED BEARINGS AT BENT NO B FOR NOTES AND DETAILS SEE DWG NO BR-12-10
- ② REMOVE EXISTING ASPHALT OVERLAY AND PROVIDE NEW 3 1/4" NEW ASPHALT OVERLAY WITH MEMBRANE DECK SEALANT SEE NOTES AND DETAILS ON DWG NO BR-12-16
- (3) INSTALL TYPE "C" STRIP SEAL EXPANSION JOINT AT PIER B, PIER E, AND PIER G FOR NOTES AND DETAILS, SEE DWG NO BR-12-11 FOR NOTES AND DETAILS
- 4 INSTALL TYPE "A" STRIP SEAL EXPANSION JOINT AT ABUTMENT K FOR NOTES AND DETAILS, SEE DWG NO BR-12-11
- (S) ADD FILL AT ABUTMENT K SLOPE TO FILL EROSION CUTS ALL WORK MUST MEET THE FULL APPROVAL OF ENGINEER
- (6) EPOXY INJECT CRACKS AT ABUTMENT "K" FOR NOTES AND DETAILS, SEE DWG NO BR-12-12
- 7 INSTALL LONGITUDINAL AND UPLIFT RESTRAINTS AT ABUTMENT A AND K FOR NOTES AND DETAILS SEE DWG NO BR-12-15
- ▲ ③ INSTALL LONGITUDINAL RESTRAINTS AT PIERS B, E, F AND G FOR NOTES AND DETAILS, SEE DWG NO BR-12-15
- (9) REPLACE MISSING RAILS AT SPANS 3 AND 6 REPAIR EXISTING POSTS AT SPANS 4, 6, AND 9 FOR NOTES AND DETAILS SEE DWG NO BR-12-13

REPAIR LEGEND

NOTES

FOR LOCATION OF REPAIRS LISTED IN THE GENERAL SCOPE OF WORK SEE CORRESPONDING NUMBERS ON THE PLAN VIEW THIS SHEET

STATE OF TENNESSEE
DEPARTMENT OF TRANSPORTATION

LAYOUT OF BRIDGE REPAIR TO BE REPAIRED
STATE ROUTE 14 OVER
NONCONNAH CREEK AND RAILROAD
BRIDGE NO 79-14-7 11R
SHELBY COUNTY

1994

DWG NO	LAST REV DATE	DRAWING
BR-12-5	6/2/94	LAYOUT OF BRIDGE TO BE REPAIRED
BR-12-6	6/2/94	LAYOUT OF BRIDGE TO BE REPAIRED
BR-12-7	6/2/94	ESTIMATED QUANTITIES AND GENERAL NOTE:
BR-12-8		BRIDGE REPAIR DETAILS
BR-12-9		BRIDGE REPAIR DETAILS
BR-12-10		BRIDGE REPAIR DETAILS
BR-12-11		BRIDGE REPAIR DETAILS
BR-12-12		BRIDGE REPAIR DETAILS
BR-12-13		BRIDGE REPAIR DETAILS
BR-12-14	6/2/94	BRIDGE REPAIR DETAILS
BR-12-15	6/2/94	BRIDGE REPAIR DETAILS
BR-12-16		BRIDGE REPAIR DETAILS

<u>NO</u>	LAST REV DATE	REGARDING
100	**	REVISIONS AND ADDITIONS TO STANDARD SPECIFICATIONS
105A	**	APPROVAL OF SHOP DRAWINGS
209	**	PROJECT EROSION AND SILTATION CONTROL
602	**	SECTION 602 STEEL STRUCTURES
603A	**	PAINTING
603B	**	CONTAINMENT AND DISPOSAL OF LEAD AND OTHER HAZARDOUS PAINT WASTES
604	**	CONCRETE STRUCTURES
604CX	**	CONTRACTOR - MIX DESIGN AND TESTING STRUCTURAL CONCRETE
604S	**	STRIP SEAL EXPANSION JOINTS
907A	**	EPOXY COATED REINFORCING STEEL

** DENOTES CURRENT REVISION DATE AS PER CONTRACT DOCUMENTS

DWG NO	LAST REV DATE	DRAWING
K-30-42 K-30-43 K-30-44 K-30-45 K-30-46 K-30-48 K-30-49 K-30-51 K-30-52 K-30-53 K-30-54 H-5-110		BRIDGE LAYOUT CENERAL NOTES AND QUANTITIES ABUTMENT A ABUTMENT K PIERS B, G, H AND J PIERS C AND D PIERS C AND F STEEL FRAMING PLAN EXPANSION DEVICE AND DIAPHRAGM DETAILS BEARING AND SPLICE DETAILS SUPERSTRUCTURE SLAB PLANS 1 - 5 SUPERSTRUCTURE SLAB PLANS 6 - 9 SUPERSTRUCTURE SLAB DETAILS - HANDRAIL AND DRAINAGE DETAILS STANDARD CONCRETE HANDRAIL

ALL REFERENCE DRAWINGS TO BE PRINTED WITH THE PLANS

 DESIGNED BY AJ KHAIRI
 DATE DECEMBER 1993

 DRAWN BY AJ KHAIRI
 DATE DECEMBER 1993

 SUPERVISED BY T JOHNSON
 DATE DECEMBER 1993

 CHECKED BY T JOHNSON
 DATE DECEMBER 1993

BRIDGE REPAIR QUANTITIES

ITEM	DESCRIPTION	UNIT	7.11L	7.11R	TOTAL
1) 203-03	BORROW EXCAVATION (UNCLASSIFIED)	CY	25	30	55
2) 209-08 0	TEMPORARY FILTER BARRIER	LF	50	50	100
307-03 15	BITUMINOUS PLANT MIX BASE (HOT MIX) GRADE "B" MOD	TON	376		376
403-01	BITUMINOUS MATERIAL FOR TACK COAT	TON	1	1	2
407-02 0	COLD PLANING OF BITUMINOUS PAVEMENT	CY	54	54	108
407-02 09	SALVAGE VALUE OF COLD PLANING	CY	54	54	108
411-01 01	MIN AGGR FOR ASPH CONC SUR <acs> GRADE "D"</acs>	TON	305	293	598
411-01 02	ASPH CEM FOR ASPH CONC SUR <acs> GRADE "D"</acs>	TON	20	19	39
411-02 01	MIN AGGR FOR ASPH CONC SUR <acs> GRADE "E"</acs>	TON	389	370	759
411-02 02	ASPH CEM FOR ASPH CONC SUR <acs> GRADE "E"</acs>	TON	25	24	49
3) 602-10 0	STRUCTURAL STEEL REPAIR	LS		1	1
4) 603-02 0	REPAINTING EXISTING STEEL STRUCTURES	LS	5	5	1
603-05 2	CONTAINMENT AND DISPOSAL OF PAINT WASTE (BR NO 79-14-711)	LS	5	5	1
5) 604-03 2	BRIDGE JOINT SEISMIC MODIFICATION	EACH	192 🗥	80 🛕	240 🔏
6) 604-10 06	CONCRETE HANDRAIL REPAIR	LF		35	35
7) 604-10 14	REMOVE EXISTING WEARING SURFACE	LS	0.5	0.5	1
8) 604-10 30	BRIDGE DECK REPAIR (FULL DEPTH OF SLAB)	SY	132	125	257
9 604-10 32	EXPANSION JOINT REPAIR (TYPE "A")	LF		53	53
9) 604-10 35	EXPANSION JOINT REPAIR (TYPE 'C")	LF	58		58
9) 604-10 40	EXPANSION JOINT REPAIR (TYPE "D")	LF		152	152
604-10 50	BRIDGE DECK REPAIR (PARTIAL DEPTH OF SLAB)	SY	525	497	1,022
11) 604-10 54	CONCRETE REPAIRS	SF	541		541
2 604-10 62	EPOXY INJECTION REPAIRS (COMPLETE AND IN-PLACE)	LF	50	15	65
617-01	BRIDGE DECK SEALANT	SY	3744	3,332	7076
712-01	TRAFFIC CONTROL	LS	0.5	0.5	1
712-02 02	INTERCONNECTED PORTABLE BARRIER RAIL	L.F	2,536	2,452	4,988
712-04 01	FLEXIBLE DRUMS (CHANNELIZING)	EACH	41	79	120
712-05 01	WARNING LIGHTS (TYPE A)	EACH	20	4	24
712-05 03	WARNING LIGHTS (TYPE C)	EACH	41	79	120
712-06	SIGNS (CONSTRUCTION)	SF	467	153	620
4) 712-06 01	VERTICAL PANELS	SF	68	68	136
	FLASHING ARROW BOARD (TYPE C)	EACH	2	1	3
	REMOVABLE PAVEMENT MARKING LINE	LF	9,990	9,184	19,174
	PLASTIC PAVEMENT MARKING (LINE)	L.M	0 56	0 54	1 10
717-01	MOBILIZATION	LS	0.5	0.5	1

- 1 INCLUDES THE COST OF ALL LABOR AND MATERIALS FOR FURNISHING, HAULING, PLACING AND COMPACTING BORROW MATERIAL ON THE EXISTING ABUTMENT SLOPES AS NECESSARY TO FILL EROSION CUTS AT THE SOUTH ABUTMENTS THE ENGINEER MAY INCREASE, DECREASE, OR ELIMINATE THE QUANTITY FOR THIS ITEM
- (2) INCLUDES THE COST OF ALL LABOR AND MATERIALS FOR FURNISHING AND INSTALLING THE TEMPORARY FILTER BARRIER WHERE LOCATED BY THE ENGINEER, AND REMOVAL UPON PROJECT COMPLETION SEE STD DWG ESC-STR-3 THE ENGINEER MAY INCREASE, DECREASE OR ELIMINATE THE QUANTITY FOR THIS ITEM
- (3) INCLUDES ALL COSTS TO RESET EIGHT (8) EXPANSION BEARINGS FOR DETAILS, SEE DWG NO BR-12-10
- (4) INCLUDES COST OF CLEANING AND PAINTING OF ALL STRUCTURAL STEEL, INCLUDING CAST SHOES, ON BOTH LEFT AND RIGHT BRIDGES, EXCEPT FOR THE THE PORTIONS OF THE TRUSS OVER THE RAILROAD TRACK THAT ARE ENCASED IN CONCRETE, WHICH SHALL NOT BE DISTURBED SEE PAINT NOTE ON THIS DRAWING ESTIMATED QUANTITY OF STRUCTURAL STEEL TO BE PAINTED IS 150 TONS (BR NO 79-14-711L) AND 740 TONS (BR NO 79-14-711R)
- (3) INCLUDES THE COST OF ALL LABOR AND MISCELLANEOUS MATERIALS NECESSARY TO INSTALL THIRTY—TWO (32) LONGITUDINAL RESTRAINTS AT PIERS B E F & G AND SIXTEEN (16) LONGITUDINAL AND UPLIFT RESTRAINTS AT ABUTMENTS A AND K AT BRIDGE NO 79-14-711R FOR NOTES AND DETAILS, SEE DWG NO BR-12-15 THIS ITEM ALSO INCLUDES THE COST OF ALL LABOR AND MATERIALS NECESSARY TO PERFORM THE FOLLOWING AT BRIDGE NO 79-14-71IL (1) PROVIDE SEISMIC RESTRAINTS AT SPAN 2, INCLUDING ALL STRUCTURAL STEEL, 1"0 A325 BOLTS, AND 1 1/2" 0 ANCHOR RODS, NUTS, AND WASHERS (4 LOCATIONS), (2) INSTALL TWENTY-ONE (21) BARS A700 EACH AT ABUTS 1 AND 2 AND BENTS 1 AND 2 (84 TOTAL), (3) PROVIDE HORIZONTAL SEISMIC RESTRAINTS AT BENTS 3-13 AND PIERS 1 AND 2, INCLUDING STRUCTURAL STEEL ANGLES AND 1 1/4" 0 ANCHOR RODS (104 LOCATIONS) FOR NOTES AND DETAILS SEE DWG NO BR-12-14 THIS ITEM WILL INCLUDE ALL COSTS ASSOCIATED WITH PAINTING ALL STEEL BEQUIPED FOR SEISMIC PERDALELTING STEEL REQUIRED FOR SEISMIC RETRO-FITTING
- $\stackrel{ullet}{ ext{0}}$ includes all costs to remove and replace concrete handrails and posts for locations and details, see DWG NO BR-12-13
- (7) INCLUDES ALL COSTS TO REMOVE EXISTING WEARING SURFACE FROM BRIDGE DECK
- (8) INCLUDES ALL COSTS TO PERFORM FULL DEPTH DECK REPAIRS SEE DECK REPAIR NOTES AND DETAILS ON DWG NO BR-12-12
- (9) INCLUDES THE COST OF ALL LABOR AND MATERIALS FOR REMOVING AND REPOURING CONCRETE, EPOXY COATED REINFORCING STEEL, MECHANICAL THREADED CONNECTORS, COUPLER BARS, REMOVAL AND REPLACEMENT OF SIDEWALK PLATES, AND STRIP SEAL EXPANSION JOINT ASSEMBLIES OF THE TYPE INDICATED FOR NOTES AND DETAILS, SEE DWG NO'S BR-12-10 AND BR-12-11
- (10) INCLUDES ALL COSTS TO PERFORM PARTIAL DEPTH DECK REPAIRS SEE DECK REPAIR NOTES AND DETAILS ON DWG NO BR-12-12
- 1) INCLUDES ALL COSTS TO PERFORM SPALL REPAIRS ON BENTS, DIAPHRAGMS, TOPS OF EXISTING HANDRAILS ON BRIDGE NO 79-14-7 11L, AND BEAMS SEE SPALL REPAIR NOTES AND DETAILS ON DWG NOS BR-12-12 AND BR-12-13
- (2) INCLUDES ALL LABOR AND MISCELLANEOUS MATERIALS NECESSARY TO COMPLETE THE EPOXY INJECTION OF EXISTING CONCRETE CRACKS. THE ENGINEER WILL DETERMINE THE LOCATIONS OF CRACKS THAT REQUIRE INJECTION. THE QUANTITY MAY BE INCREASED, DECREASED OR ELIMINATED BY ENGINEER
- (3) INCLUDES THE COST OF ALL LABOR AND MATERIALS NECESSARY FOR PLACING BRIDGE DECK SEALANT MEMBRANE FOR FULL WIDTH AND LENGTH OF BRIDGES, 2-0' PAST BEGINNING AND END OF BOTH BRIDGES WHERE REQUIRED, AND 3' WIDTH AT DESIGNATED TRANSVERSE JOINTS IT ALSO INCLUDES THE COST OF ALL LABOR AND MISCELLANEOUS MATERIALS NECESSARY TO CLEAN AND SEAL JOINTS SEE NOTES AND DETAILS ON DWG NO'S BR-12-12 AND BR-12-16
- (14) INCLUDES 68 S F OF VP-1L AND 68 S F OF VP-1R
- (15) PERMANENT PAVEMENT MARKING SHALL BE THERMOPLASTIC ONLY
- (16) INCLUDES ALL COST FOR CONTAINMENT AND DISPOSAL OF PAINT WASTES SEE PAINT NOTES THIS DWG

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GENERAL NOTES

SPECIFICATIONS STANDARD ROAD AND BRIDGE SPECIFICATIONS OF THE TENNESSEE DEPARTMENT OF TRANSPORTATION (MARCH 1981 EDITION)

DESIGN SPECIFICATIONS AASHTO 1992 EDITION WITH ADDENDA

STRUCTURAL STEEL SHALL CONFORM TO AASHTO M270 GRADE 36 (ASTM A709 GRADE 36) UNLESS OTHERWISE NOTED

REINFORCING STEEL TO BE ASTM A615 GRADE 60 STANDARD CRSI HOOK DETAILS APPLY UNLESS OTHERWISE NOTED ON BILL OF STEEL SPACING DIMENSIONS ARE CENTER TO CENTER AND COVER DIMENSIONS ARE CLEAR DISTANCE UNLESS OTHERWISE NOTED PLACING TOLERANCES ARE ±1/2" FOR SPACING AND −1/8" OR +3/8" FOR COVER (THE SUFFIX E FOR BARS SO MARKED, DENOTES EPOXY COATED REINFORCEMENT) SEE SPECIAL PROVISION 907A

MECHANICAL BAR SPLICERS MUST BE APPROVED BY THE DIVICION OF MATERIALS AND TESTS A SPLICED SAMPLE OF EACH SIZE BAR APPROXIMATELY TWO FEET (2") IN LENGTH SHALL BE SUBMITTED TO THE DIVISION OF MATERIALS AND TESTS THE SAMPLES MUST BE MADE IN THE PRESENCE OF THE ENGINEER BY THE SAME PERSONNEL AND EQUIPMENT THAT WILL BE MAKING THE PRODUCTION SPLICES THE BAR SPLICER SHALL MEET AASHTO STANDARD SPECIFICATIONS FOR MECHANICAL CONNECTION WHEN EPOXY COATING IS STANDARD SPECIFICATIONS FOR MECHANICAL CONNECTION WHEN EFOXT CONTING IS

REQUIRED, THE EXPOSED THREADS SHALL BE REPAIRED AFTER SPLICING ACCORDING TO

SPECIAL PROVISION 907A THE COST OF FURNISHING BAR SPLICERS (AND EPOXY COATING
WHEN REQUIRED), INCLUDING ALL LABOR AND MATERIALS NECESSARY FOR COMPLETE INSTALLATION SHALL BE INCLUDED IN THE UNIT PRICE BID FOR ITEM NO 604-1018, LBS

SHOP DRAWINGS SHALL BE SUBMITTED ACCORDING TO SPECIAL PROVISION NO 105A, EXCEPT SHOP DRAWINGS SHALL BE SUBMITTED TO THE HEADQUARTERS BRIDGE INSPECTION AND REPAIR OFFICE IN LIEU OF THE DIVISION OF STRUCTURES

BOLTS SHALL BE HIGH TENSILE STRENGTH BOLTS (ASTM-A325), UNLESS OTHERWISE NOTED SIZE TO BE AS NO LED ON THANS SEE AASHTO SPECIFICATIONS, ARTICLE 11.5 6, DIVISION II. EXISTING CONTACT SUFFACES SHALL BE CLEANED TO SSPC-10 SPECIFICATIONS PRIOR TO ATTACHMENT OF NEW MEMBERS

HIGH EARLY STRENGTH CONCRETE THE MIX SHALL MEET THE REQUIREMENTS OF SPECIAL PROVISION NO 604CX, CLASS "A", EXCEPT THE CEMENT CONTENT SHALL BE A MINIMUM OF 714 LBS, THE WATER CEMENT RATIO SHALL BE A MAXIMUM OF 0 40, NO FLY ASH
REPLACEMENT WILL BE PERMITTED AND THE MINIMUM 28 DAY COMPRESSIVE STRENGTH
SHALL BE 3,500 P.S.I. TRAFFIC SHALL NOT BE PERMITTED ON ON ANY OF THE REPAIR AREAS UNTIL TEST SPECIMENS ATTAIN A COMPRESSIVE STRENGTH OF 3000 PS I MINIMUM AND

 $\underline{\text{BRIDGE DECK SURFACE FINISH}}$ TO BE IN ACCORDANCE WITH NOTE (A), SHEET 5, OF SPECIAL PROVISION NO $\,604$

 $\underline{\text{CONCRETE}}$ CURING ALL CONCRETE IN REPAIR AREAS SHALL BE CURED ACCORDING TO SPECIAL PROVISION NO $\,604$

WELDING ANSI/AASHTO/AWS D1 5-88 BRIDGE WELDING CODE SPECIAL PROVISION

NON-PAY ITEMS ONLY ITEMS SHOWN ON THE PROPOSAL AS PAY ITEMS WILL BE PAID FOR COMPENSATION FOR ALL LABOR, MATERIALS, TOOLS, EQUIPMENT, AND INCIDENTALS FOR THE ENTIRE CONTRACT SHALL BE INCLUDED IN THE PRICE FOR THE PAY ITEMS

SPECIAL NOTE. TO IMPROVE THE FLOWABILITY OF THE CONCRETE. THE CONTRACTOR MAY USE ADMIXTURES, (SUPERPLASTICIZERS) IN ACCORDANCE WITH SPECIAL PROVISION NO 604CX CONCRETE ADMIXTURES (SUPERPLASTICIZERS) USED SHALL BE APPROVED BY THE TENNESSEE DEPARTMENT OF TRANSPORTATION MATERIALS AND TEST DIVISION PRIOR TO USE COARSE AGGREGATE FOR THE CONCRETE USED IN THE REPAIR AREAS SHALL BE SIZE 67 STONE

GROUTED BARS IN DRILLED HOLES HORIZONTALLY DRILLED HOLES SHALL BE DRILLED 1/2" IN DIAMETER LARGER THAN THE BAR, CLEANED, PACKED WITH NON-SHRINK GROUT AND DRIVEN TO ITS SEAT VERTICALLY DRILLED HOLES SHALL BE DRILLED 1/4" IN DIAMETER LARGER THAN THE BAR CLEANED, PACKED WITH EPOXY GROUT AND DRIVEN TO ITS SEAT ALL GROUTING

DEMOLITION. THE CONTRACTOR SHALL TAKE SPECIAL CARE TO PROTECT ANY PARTS OF THE STRUCTURE THAT ARE NOT TO BE REMOVED SPECIALLY THE COURSE ANY PARTS OF THE DEMOLITION : THE CONTRACTOR SHALL TAKE SPECIAL CARE TO PROTECT ANY PARTS OF THE STRUCTURE THAT ARE NOT TO BE REMOVED SPECIFICALLY, THE CONTRACTOR IS NOT ALLOWED TO USE A HYDRAULIC RAM MOUNTED ON A BACKHOE (COMMONLY CALLED A HOE RAM) OR OTHER SIMILARLY HEAVY EQUIPMENT FOR CONCRETE REMOVAL DEMOLITION HAMMER WEIGHT SHALL BE LIMITED TO 30 LB OR LESS ALL DEVICES PROPOSED FOR CONCRETE DEMOLITION SHALL MEET WITH APPROVAL OF THE ENGINEER SAWING OR CUTTING OF CONCRETE SHALL BE ACCEPTABLE AS LONG AS SUFFICIENT SPLICE LENGTHS OF EXISTING REBAR ARE MAINTAINED

SPECIAL NOTE CONCERNING CONCRETE REMOVAL AND WORK PERFORMED UNDER THIS CONTRACT
THE CONTRACTOR SHALL COMPLY FULLY WITH ANY REQUIREMENTS ESTABLISHED BY THE CORPS
OF ENGINEERS, U.S. COAST GUARD, AND ANY AGENCIES WHICH MAY HAVE JURISDICTION RELATIVE TO CONSTRUCTION WORK OVER A NAVIGABLE STREAM WHICH IS APPLICABLE TO THIS CONTRACT, AND WHICH MAY NOT BE COVERED BY EXISTING PERMITS

FOR ADDITIONAL GENERAL NOTES APPLICABLE TO STRIP SEAL EXPANSION JOINTS, SEE STANDARD DRAWING NO BR-2-115 ALSO SEE SPECIAL PROVISION NO 604S REGARDING STRIP SEAL EXPANSION JOINTS

UTILITY NOTES

THE LOCATION OF UTILITIES SHALL BE FIELD LOCATED BY THE CONTRACTOR, AND BY CONTACTING THE UTILITY COMPANIES INVOLVED

UNLESS OTHERWISE NOTED, ALL UTILITY ADJUSTMENTS WILL BE PERFORMED BY THE UTILITY OR ITS REPRESENTATIVE. THE CONTRACTOR AND UTILITY OWNERS WILL BE REQUIRED TO CO-OPERATE WITH EACH OTHER IN ORDER TO EXPEDITE THE WORK REQUIRED BY THIS

THE CONTRACTOR WILL PROVIDE ALL NECESSARY PROTECTIVE MEASURES TO SAFEGUARD EXISTING UTILITIES FROM DAMAGE DURING CONSTRUCTION OF THIS PROJECT IN THE EVENT THAT SPECIAL EQUIPMENT IS REQUIRED TO WORK OVER AND AROUND THE UTILITIES, THE CONTRACTOR WILL BE REQUIRED TO FURNISH SUCH EQUIPMENT THE COST OF PROTECTING UTILITIES FROM DAMAGE AND FURNISHING SPECIAL EQUIPMENT WILL BE INCLUDED IN THE PRICE BID FOR OTHER ITEMS OF CONSTRUCTION

THE CONTRACTOR WILL BE SOLELY RESPONSIBLE FOR CONTACTING ALL AFFECTED UTILITIES THE CONTRACTOR WILL BE SOLELY RESPONSIBLE FOR COUNTACTING ALL AFFECTED STITLINES PRIOR TO SUBMITTING HIS BID. IN ORDER TO DETERMINE THE EXTENT TO WHICH UTILITY RELOCATIONS AND/OR ADJUSTMENTS WILL HAVE UPON THE SCHEDULE OF THE WORK FOR THE PROJECT SOME UTILITY FACILITIES MAY NEED TO BE ADJUSTED CONCURRENTLY WITH THE CONTRACTOR'S OPERATIONS, WHILE SOME WORK MAY BE REQUIRED "AROUND" UTILITY FACILITIES THAT WILL REMAIN IN PLACE. IT IS UNDERSTOOD AND AGREED THAT THE CONTRACTOR WILL RECEIVE NO ADDITIONAL COMPENSATION FOR ANY DELAYS OR INCONVENIENCE CAUSED BY THE

THE CONTRACTOR SHALL NOTIFY EACH INDIVIDUAL OWNER OF HIS PLAN OF OPERATION IN THE AREA OF UTILITIES PRIOR TO COMMENCING WORK, THE CONTRACTOR SHALL CONTACT OWNERS AND REQUEST THEM TO PROPERLY RELOCATE THEIR RESPECTIVE UTILITY ON THE GROUND THIS NOTIFICATION SHALL BE GIVEN AT LEAST THREE (3) BUSINESS DAYS PRIOR TO COMMENCEMENT OF OPERATIONS AROUND THE UTILITY

CONST. WORK ZONE TRAFFIC CONTROL

ADVANCED WARNING SIGNS SHALL NOT BE DISPLAYED MORE THAN FORTY-EIGHT (48) HOURS BEFORE PHYSICAL CONSTRUCTION BEGINS SIGNS MAY BE ERECTED UP TO ONE WEEK BEFORE NEEDED, IF THE SIGN FACE IS FULLY COVERED

IF THE CONTRACTOR MOVES OFF THE PROJECT, HE SHALL COVER OR REMOVE ALL UNNEEDED SIGNS AS DIRECTED BY THE ENGINEER COSTS OF REMOVAL, COVERING, AND REINSTALLING SIGNS SHALL NOT BE MEASURED AND PAID FOR SEPARATELY, BUT ALL COSTS SHALL BE INCLUDED IN THE ORIGINAL UNIT PRICE BID FOR ITEM NO 712-01, TRAFFIC CONTROL, LUMP SUM

A LONG TERM BUT SPORADIC USE WARNING SIGN, SUCH AS FLAGGER SIGNS, MAY REMAIN IN PLACE WHEN NOT REQUIRED PROVIDED THE SIGN FACE IS FULLY COVERED

TRAFFIC CONTROL DEVICES SHALL NOT BE DISPLAYED OR ERECTED UNLESS RELATED CONDITIONS ARE PRESENT

USE OF BARRICADES, PORTABLE BARRIER RAILS, VERTICAL PANELS, AND DRUMS SHALL BE LIMITED TO THE IMMEDIATE AREAS OF CONSTRUCTION WHERE A HAZARD IS PRESENT THESE DEVICES SHALL NOT BE STORED ALONG THE ROADWAY WITHIN THIRTY (30) FEET OF THE EDGE OF THE TRAVELED WAY BEFORE OR AFTER USE UNLESS PROTECTED BY GUARDRAIL, BRIDGE RAIL, AND/OR BARRIERS INSTALLED FOR OTHER PURPOSES THESE DEVICES SHALL BE REMOVED FROM THE CONSTRUCTION WORK ZONE WHEN THE ENGINEER DETERMINES THEY ARE NO LONGER NEEDED WHERE THERE IS INSUFFICIENT RIGHT-OF-WAY TO PROVIDE FOR THIS THIRTY (30) FEET SETBACK, THE ENGINEER SHALL APPROVE ALTERNATE LOCATIONS

THE CONTRACTOR WILL NOT BE PERMITTED TO PARK ANY VEHICLES OR CONSTRUCTION EQUIPMENT DURING PERIODS OF INACTIVITY, WITHIN THIRTY (30) FEET OF THE EDGE OF PAVEMENT WHEN THE LANE IS OPEN TO TRAFFIC, UNLESS PROTECTED BY GUARDRAIL, BRIDGE RAIL, AND/OR BARRIERS INSTALLED FOR OTHER PURPOSES PRIVATELY OWNED VEHICLES SHALL NOT BE ALLOWED TO BE PARKED WITHIN THIRTY (30) FEET OF AN OPEN TRAFFIC LANE AT ANY TIME UNLESS PROTECTED AS DESCRIBED ABOVE WHERE THERE IS INSUFFICIENT RIGHT-OF-WAY TO PROVIDE FOR THIS THIRTY (30) FEET SETBACK, THE ENGINEER SHALL APPROVE ALTERNATE LOCATIONS

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79	9022-422	21-04	1994	2		
REVISIONS						
NO	DATE	BY		BRIEF DESCRIPTION		
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SURFACE PREPARATION AND PAINTING OF EXISTING STEEL

(APPLICABLE TO ALL EXISTING, EXPOSED STRUCTURAL STEEL)

SURFACE PREPARATION (APPLICABLE TO ALL STRUCTURAL STEEL TO BE PAINTED)

- 1) ANY OIL OR GREASE SHALL BE REMOVED BY MEANS OF SOLVENT CLEANING IN ACCORDANCE WITH SSPC-SP1 SOLVENTS SHALL BE SAFE AND BIODEGRADABLE ALL CHALK, LOOSE COATINGS AND OTHER CONTAMINANTS SHALL BE REMOVED WITH HIGH PRESSURE WATER WASH HIGH PRESSURE WATER WASH IS DEFINED AS USING PRESSURES FROM 3,000 TO 6000 PSI AT 8 TO 10 GPM WATER
- 2) A HAND OR POWER TOOL CLEANING, IN ACCORDANCE WITH TENNESSEE STANDARD SPECIFICATIONS, SUB SECTION 603 05(a), SHALL BE APPLIED TO ALL AREAS THROUGHOUT THE BRIDGE THAT HAVE VISIBLE RUST OR EXPOSED STEEL THE ENGINEER SHALL DESIGNATE ALL AREAS THAT ARE TO RECEIVE THE HAND OF POWER TOOL CLEANING ALL HAND OR POWER TOOL CLEANING SHALL BE DONE TO THE COMPLETE SATISFACTION OF THE ENGINEER ALL EXPOSED STRUCTURAL STEEL WITHIN THESE AREAS SHALL BE SPOT PRIMED IMMEDIATELY AFTER

PAINTING SYSTEM

(TO BE APPLIED OVER ALL EXISTING STRUCTURAL STEEL, EXCEPT AS NOTED)

CONSISTING OF AN UNIVERSAL PRIMER, AND A HIGH BUILD ALIPHATIC POLYURETHANE FINISH COAT THE FINISH COAT SHALL COMPLY WITH TENNESSEE SPECIAL PROVISION NO 603A, AND SHALL DISPLAY COMPATIBILITY WITH AND ADHESION TO THE CURED UNIVERSAL PRIMER WHEN APPLIED WITH AND ADMESTON TO THE CURED UNIVERSAL PRIMER WHEN APPLIED DIRECTLY OVER THE UNIVERSAL PRIMER IN ACCORDANCE WITH THE MANUFACTURERS CURRENT PRINTED INSTRUCTIONS COLOR OF THE URETHANE FINISH COAT SHALL COMPLY WITH FEDERAL STANDARD NO 595A, 24110 BRIGHT GREEN SEE SECTIONS 603 AND 910 OF THE STANDARD SPECIFICATIONS FOR ROAD AND BRIDGE CONSTRUCTION OF THE TENNESSEE DEPARTMENT OF

SPECIAL PRIMER SYSTEM (APPLIES TO BRIDGE NO 79-14-7 11R, SPAN 8 STRUCTURAL STEEL ONLY)

THE PRIMER SYSTEM SHALL BE A ONE (1) COAT SINGLE PACKAGE, OIL MODIFIED ALKYD, THAT IS LEAD FREE THE PAINT SHALL DISPLAY COMPATIBILITY WITH AND ADHESION TO THE SPOT PRIMER AND THE PRESENT RED LEAD AND ALUMINIUM PAINT SYSTEM WHEN APPLIED DIRECTLY OVER THE PRESENT PAINT, IN ACCORDANCE WITH THE MANUFACTURERS CURRENT PRINTED INSTRUCTION SEE SECTION 603 OF THE STANDARD SPECIFICATIONS FOR ROAD AND BRIDGE CONSTRUCTION OF THE TENNESSEE DEPARTMENT OF TRANSPORTATION

PRIMER SYSTEM DESCRIPTION
(TO BE APPLIED OVER BRIDGE 79-14-7 11R, SPAN 8 ONLY)
THE COATING SYSTEM SPECIFIED HERE-IN SHALL BE APPLIED IN ORDER TO

- 1) SURFACE PREPARATION (SEE NOTES ABOVE)
 A) SPOT PRIMER CARBOLINE GRID GUARD 2600 FD AT 2 MILS MINIMUM
- DRY FILM THICKNESS

 B) FINISH CARBOLINE GRID GUARD 2600 FD AT 2 TO 4 MILS MINIMUM DRY FILM THICKNESS

MEET THE FOLLOWING REQUIREMENTS

- 2) PRODUCTS
 A) SHALL BE CARBOLINE GRID GUARD 2600 AND CARBOLINE GRID GUARD 2600
- B) ALL PRODUCTS USED IN THIS COATING SYSTEM, INCLUDING THINNERS, MUST BE SUPPLIED BY SAME MANUFACTURERS

APPLICATION
THE COATING APPLICATOR SHALL FOLLOW THE MANUFACTURERS PRINTED INSTRUCTIONS, AND SHALL HAVE THESE INSTRUCTIONS ON SITE DURING THE

COATING SYSTEM DESCRIPTION (TO BE APPLIED OVER ALL STRUCTURAL STEEL WITH THE EXCEPTION OF THE PRIMER SYSTEM ON 79-14-7 11R, SPAN 8 ONLY, AND PORTION OF

BOTTOM TRUSS ON 79-14-7 11L) THE COATING SPECIFIED HERE-IN SHALL BE APPLIED IN ORDER TO MEET THE

FOLLOWING REQUIREMENTS

1) SURFACE PREPARATION (SEE NOTES ABOVE)

- A) SPOT PRIMER UNIVERSAL AT 3 MILS MINIMUM DRY FILM THICKNESS
- B) PRIMER UNIVERSAL AT 3 MILS MINIMUM DRY FILM THICKNESS
- C) FINISH TWO COMPONENT HIGH BUILD ALIPHATIC POLYURETHANE A:

- A) THE UNIVERSAL PRIMFRS SHALL BE BE <u>CAVIS PAINT</u> P67 BLOX METAL PRIMER, <u>CARBOLINE</u> RUST BOND 8HB PRIMER, OR <u>DEVOE</u> BAR-OX P-50, OR AN APPROVED EQUAL
- DEPARTMENT OF TRANSPORTATION'S QUALIFIED PRODUCT LIST FOR PAINT THE HIGH BUILD ALIPHATIC POLYURETHANE SHALL BE IN ACCORDANCE WITH SPECIAL PROVISION NO 603A
- B) ALL PRODUCTS USED IN THIS COATING SYSTEM INCLUDING THINNERS, MUST BE SUPPLIED BY THE SAME MANUFACTURER

APPLICATION
THE COATING APPLICATOR SHALL FOLLOW MANUFACTURERS PRINTED INSTRUCTIONS AND SHALL HAVE THESE INSTRUCTIONS ON SITE DURING THE COURSE OF THE WORK

PROTECTION OF PROPERTY

EXTREME CARE SHALL BE TAKEN WHEN PAINTING THESE STRUCTURES TO PROTECT THE GENERAL PUBLIC AND THE SURROUNDING ENVIRONMENT


CONTAINMENT
THE EXISTING PAINT SYSTEM CONTAINS RED LEAD PAINT WHICH HAS BEEN DESIGNATED AS A HAZARDOUS MATERIAL THE CONTRACTOR IS RESPONSIBLE FOR CONTAINMENT, HANDLING, AND DISPOSAL OF THE RED LEAD PRINT, REMOVED AS INDICATED ON THE PLANS, IN ACCORDANCE WITH ALL FEDERAL, STATE, AND LOCAL LAWS THIS MATERIAL IS TO BE PREVENTED FROM ENTERING THE ENVIRONMENT THE CONTRACTOR SHALL CONTAIN AND DISPOSE OF ALL PAINT REMOVAL WASTE IN ACCORDANCE WITH SPECIAL PROVISION NO 603B PLANS, ETC., REGARDING THE ABOVE ARE TO BE SUBMITTED TO THE ENGINEER FOR PROVISION AND ADDROVAL ALL COSTS. TO BE INCLUDED IN TIEMS BUD ON REVIEW AND APPROVAL ALL COSTS TO BE INCLUDED IN ITEMS BID ON

> STATE OF TENNESSEE DEPARTMENT OF TRANSPORTATION

PAINTING NEW STEEL

PAINTING THE NEW STRUCTURAL STEEL FOR THE SEISMIC RETRO—FIT PAINT SHALL BE SYSTEM "B" — INORGANIC ZINC—PAINT SYSTEM, EXCEPT A URETHANE FINISH COAT SHALL BE USED IN LIEU OF VINYL FINISH COAT COLOR OF THE URETHANE FINISH COAT SHALL COMPLY WITH FEDERAL STANDARD NO 595A, 24110 BRIGHT GREEN SEE SECTIONS 603 AND 910 OF THE STANDARD SPECIFICATIONS FOR ROAD AND BRIDGE CONSTRUCTION OF THE TENNESSEE DEPARTMENT OF TRANSPORTATION AN INTERMEDIATE TIE COAT SHALL BE USED SEE SPECIAL PROVISION NO 603A, REGARDING PAINTING

ESTIMATED QUANTITIES AND GENERAL NOTES STAIL ROUTE 14 OVER NONCONNAH CREEK AND RAILROAD BR NOS 79-14-711 L & R SHELBY COUNTY

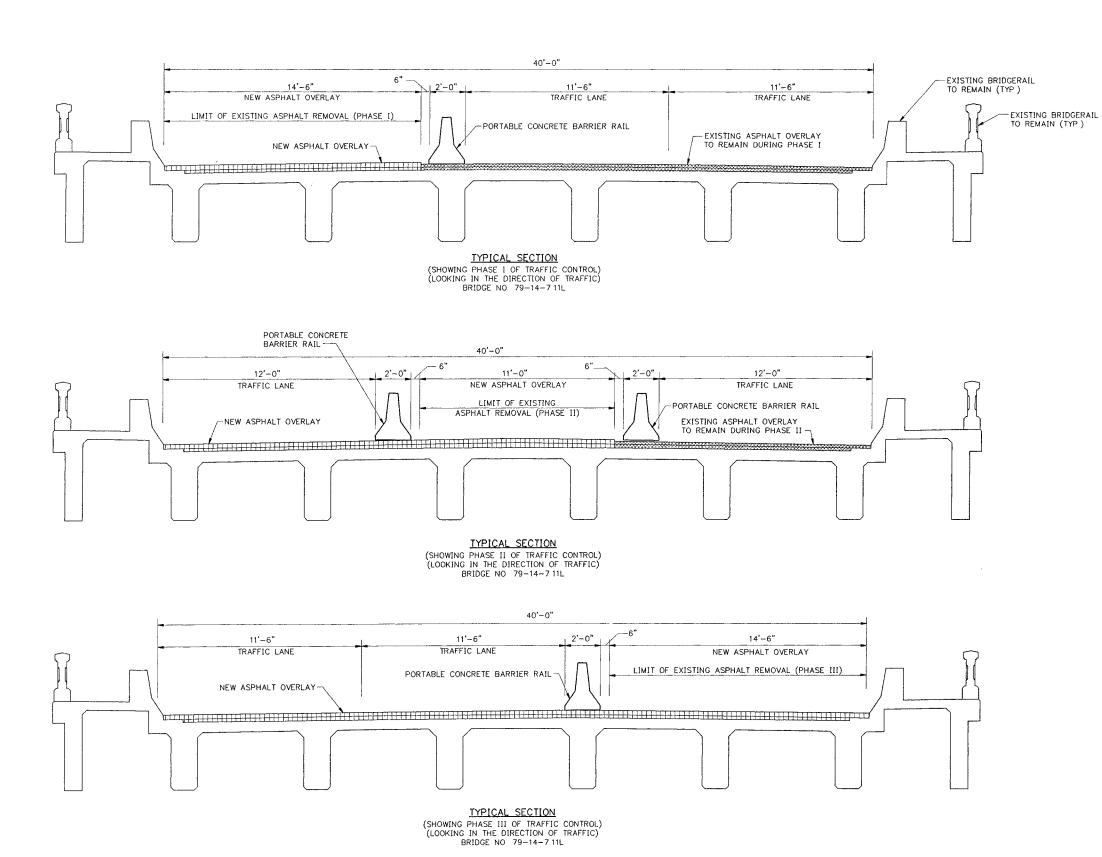

PROJECT NO. YEAR SHEET NO. 790224221-04 1994 REVISIONS BRIEF DESCRIPTION

NOTES

ALL COST ASSOCIATED WITH INTERCONNECTED PORTABLE BARRIER RAIL SHALL BE INCLUDED UNDER ITEM NO 712-02 02

ALL COST ASSOCIATED WITH ASPHALT REMOVAL SHALL BE INCLUDED UNDER ITEM NO $604-10\,14$, REMOVE EXISTING WEARING SURFACE, LS

FOR DETAILS ON NEW ASPHALT OVERLAY, SEE DWG NO BR-12-16

AT EACH PHASE, THE CONTRACTOR SHALL REMOVE EXISTING ASPHALT OVERLAY AND REPLACE IT WITH NEW 3 1/4" ASPHALT OVERLAY BEFORE STARTING A NEW PHASE THE LIMITS OF ASPHALT REMOVAL AND REPLACEMENT PER PHASE ARE SHOWN ON THE DETAILS OF THIS DWG


FOR MORE DETAILS ON TRAFFIC CONTROL, SEE SHEETS NO'S 3, 4, AND 5

STATE OF TENNESSEE DEPARTMENT OF TRANSPORTATION

BRIDGE REPAIR DETAILS STATE ROUTE 14 OVER NONCONNAH CREEK AND RAILROAD BR. NOS. 79-14-711 L SHELBY COUNTY

1994


DESIGNED BY A J KHAIR!
DRAWN BY A J KHAIR!
SUPERVISED BY T JOHNSON
CHECKED BY T JOHNSON DATE DECEMBER 1993
DATE DECEMBER 1993
DATE DECEMBER 1993
DATE DECEMBER 1993

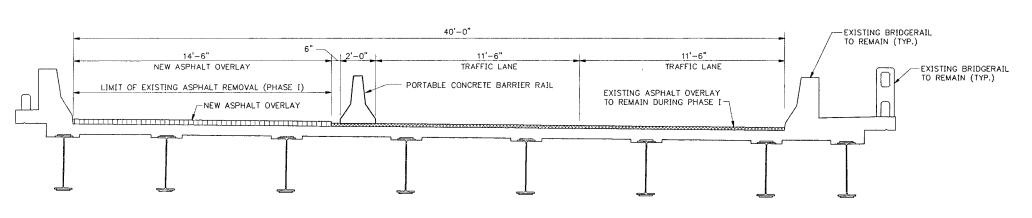

PROJECT NO. YEAR 79022-4221-04 1994 REVISIONS BRIEF DESCRIPTION


TYPICAL SECTION

(SHOWING PHASE I OF TRAFFIC CONTROL) (LOOKING IN THE DIRECTION OF TRAFFIC) BRIDGE NO. 79-14-7.11R

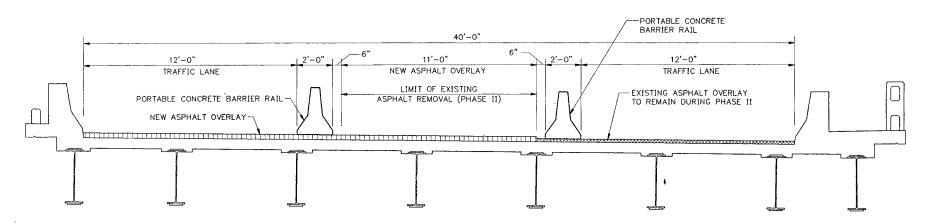

TYPICAL SECTION

(SHOWING PHASE II OF TRAFFIC CONTROL) (LOOKING IN THE DIRECTION OF TRAFFIC) BRIDGE NO. 79-14-7.11R

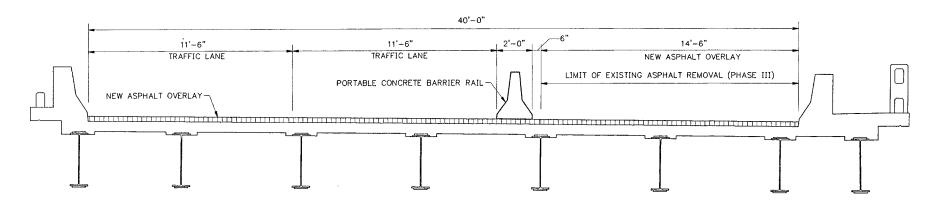

TYPICAL SECTION
(SHOWING PHASE III OF TRAFFIC CONTROL)
(LOOKING IN THE DIRECTION OF TRAFFIC) BRIDGE NO. 79-14-7.11R

ALL COST ASSOCIATED WITH INTERCONNECTED PORTABLE BARRIER RAIL SHALL BE INCLUDED UNDER ITEM NO. 712-02.02.

ALL COST ASSOCIATED WITH ASPHALT REMOVAL SHALL BE INCLUDED UNDER ITEM NO. 604-10.14, REMOVE EXISTING WEARING SURFACE, L.S.

FOR DETAILS ON NEW ASPHALT OVERLAY, SEE DWG. NO BR-12-16.

AT EACH PHASE, THE CONTRACTOR SHALL REMOVE EXISTING ASPHALT OVERLAY AND REPLACE IT WITH NEW 3 1/4" ASPHALT OVERLAY BEFORE STARTING A NEW PHASE. THE LIMITS OF ASPHALT REMOVAL AND REPLACEMENT PER PHASE ARE SHOWN ON THE DETAILS OF THIS DWG.


FOR MORE DETAILS ON TRAFFIC CONTROL, SEE SHEETS NO'S. 3, 4, AND 5.

STATE OF TENNESSEE DEPARTMENT OF TRANSPORTATION

BRIDGE REPAIR DETAILS STATE ROUTE 14 OVER NONCONNAH CREEK AND RAILROAD BR. NOS. 79-14-7.11 R SHELBY COUNTY

1994


DESIGNED BY A J KHAIRI
DRAWN BY A J KHAIRI
SUPERVISED BY T JOHINSON
CHECKED BY T JOHNSON

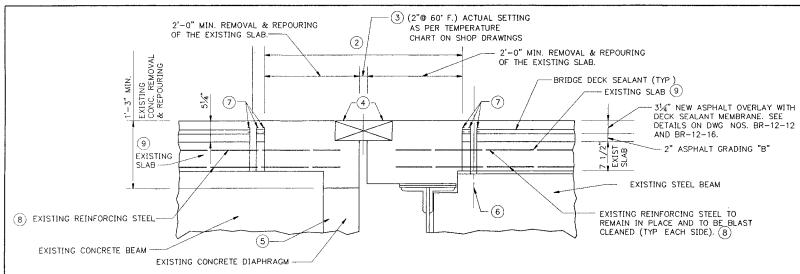

EXPANSION JOINT REPLACEMENT DETAIL

TYPE "D" (ITEM NO. 604-10 40)
(SEE EXPANSION JOINT REPLACEMENT DETAILS TYPE "D" ON STD DWG NO. BR-2-118) (TYPICAL AT BENT NO. 1 BRIDGE NO 79-14-7.11L)

LIMITS OF PAYMENT FOR ITEM NO 604-10.40, L.F.

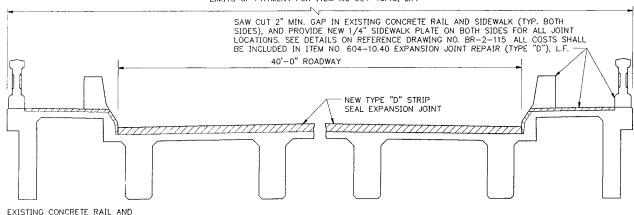

CROSS SECTION SHOWING LIMITS OF NEW

TYPE "D" STRIP SEAL EXPANSION JOINT

NOTES:

SIDEWALK SHALL BE SAW CUT AS

NECESSARY TO PROVIDE 3" GAP

BETWEEN SPANS.


- (1) ALL CONCRETE POURS SHALL BE WELL CONSOLIDATED BEHIND AND AROUND THE EXPANSION JOINT STEEL RETAINER.
- (2) SEE EXPANSION JOINT REPLACEMENT DETAIL, TYPE "D" ON STANDARD DRAWING NO. BR-2-118. FOR FURTHER DETAILS AND NOTES, SEE STANDARD DRAWING NO'S. BR-2-115, BR-2-116, AND SPECIAL PROVISION NO. 604S.
- SET ALL EXPANSION JOINT REPLACEMENTS 2" (TWO INCHES) AT MID-TEMPERATURE OF 60° F., WITH A TOTAL MOVEMENT REQUIRED OF 4" (FOUR INCHES). ACTUAL SETTING AS PER TEMPERATURE CHART ON EXPANSION JOINT
- (4) SEE TYPE "X" MEMBRANE RETAINER AND NOTES ON STANDARD DRAWING NO. BR-2-116. FOR ADDITIONAL DETAILS AND NOTES, SEE STANDARD DRAWING NO'S, BR-2-115, AND BR-2-118.
- (5) FOR LEVELING BOLT ASSEMBLIES NOT SHOWN, SEE DETAILS ON STANDARD DRAWING NOS. BR-2-116, AND BR-2-118
- (6) CONTRACTOR TO DRILL A 11/2" # HOLE NEAR FACE OF CURB AT LOW POINT AT EACH SIDE OF BRIDGE.
- (7) MASTIC AS RECOMMENDED BY MANUFACTURER OF MEMBRANE SEE STANDARD SPECIFICATIONS, ARTICLE 906 04
- EXTREME CARE SHALL BE TAKEN WHEN REMOVING CONCRETE SLAB SO AS NOT TO DAMAGE THE EXISTING LONGITUDINAL REINFORCING STEEL ALL EXISTING LONGITUDINAL REINFORCING STEEL SHALL BE BLAST CLEANED AND INCORPORATED WITH (8) NEW REINFORCING STEEL ALL WORK MUST MEET WITH FULL SATISFACTION OF THE ENGINEER.
- THE CONTRACTOR SHALL BE FULLY RESPONSIBLE FOR SUPPORTING THE PORTIONS OF THE SLAB WHICH ARE NOT TO BE REMOVED WHEN MAKING REPAIRS WHICH REQUIRE THE REMOVAL OF THE END SUPPORT OF A SLAB SPAN. DETAILS OF THE SUPPORT SYSTEM SHALL BE SUBMITTED TO THE ENGINEER FOR REVIEW. COST OF THE SUPPORT SYSTEM TO BE INCLUDED IN ITEMS BID ON.
- (10) CONCRETE FOR ALL EXPANSION JOINT REPAIR AREAS TO BE HIGH EARLY STRENGTH CONCRETE, I'C = 3500 PSI @ 28 DAYS.
- COST OF REMOVING CONCRETE FOR THE LIMITS SHOWN, REPOURING WITH HIGH EARLY STRENGTH CONCRETE, EPOXY COATED REINFORCING STEEL, MECHANICAL THREADED CONNECTORS, COUPLER BARS, REMOVAL AND REPLACEMENT OF SIDEWALK PLATES, AND EXPANSION JOINT ASSEMBLIES SHALL BE PAID FOR UNDER ITEM NO. 604-10 40, EXPANSION JOINT REPAIR (TYPE "D"), L.F.
- COST OF INCIDENTALS SUCH AS WELDING, BLAST CLEANING, SAW CUTTING, DRILLING, ETC. AND MISCELLANEOUS MATERIALS NECESSARY TO COMPLETE THE INSTALLATION OF THE NEW EXPANSION JOINTS AT BENT NO. 1 BRIDGE NO. 79-14-7.11L, SHALL BE INCLUDED UNDER TTEMS BID ON

DESIGNED BY A J KHAIRI
DRAWN BY A J KHAIRI
SUPERVISED BY T JOHNSON
CHECKED BY T JOHNSON

7.111

THE CONTRACTOR SHALL USE MECHANICAL THREADED CONNECTORS TO SPLICE TRANSVERSE REINFORCEMENT

BETWEEN CONSTRUCTION OF EACH PHASE, SEE BAR CONNECTOR DETAIL ON THIS DWG. FOR NOTES AND

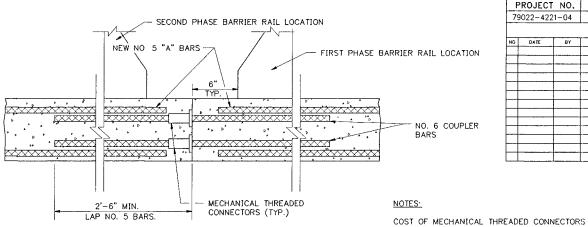

WITH COUPLER BARS TO BE INCLUDED IN ITEMS BID ON. INSTALLATION MUST MEET WITH THE FULL APPROVAL OF THE ENGINEER

EXISTING STEEL GIRDERS

EXISTING Q

RESET Q-

MECHANICAL THREADED CONNECTORS WITH COUPLER BARS ARE TO BE USED WITH NEW NO. 5 "A" BARS IN THE EXPANSION JOINT REPLACEMENT. SEE STD. DWG. NOS BR-2-117 AND BR-2-118 FOR LOCATION OF "A" BARS.

PROJECT NO.

79022-4221-04

YEAR


REVISIONS

SHEET NO.

BRIEF DESCRIPTION

BEARING POSITION

AFTER RESETTING @ 60° F.

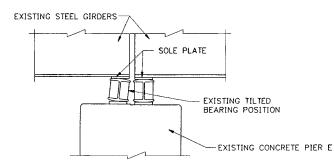

BAR CONNECTOR DETAIL

SHOWING TRANSVERSE REINFORCING

STEEL SPLICING WITH MECHANICAL

THREADED CONNECTORS

EXISTING EXPANSION BEARINGS

EXISTING EIGHT (8) TILTED EXPANSION BEARINGS AT PIER E OF BRIDGE 79-14-7.11R

RESET EXPANSION BEARING

NOTES:

BEARING DEVICES ARE TO BE SET TO A VERTICAL POSITION AT 60 DEGREES FAHRENHEIT. AT TEMPERATURES OTHER THAN 60 DEGREES FAHRENHEIT, BEARING SHALL BE SET AS INSTRUCTED BY THE ENGINEER. TEMPERATURE SHALL BE BEAM TEMPERATURE. ALL WORK MUST MEET WITH THE FULL SATISFACTION OF ENGINEER.


COST OF RESETTING EIGHT (8) EXPANSION BEARINGS AT BRIDGE NO. 79-14-7.11R, INCLUDING ALL JACKING, REMOVING THE EXISTING SOLE PLATE AND REWELDING TO THE BOTTOM FLANGE OF THE GIRDER, TOUCH-UP PAINTING, LABOR, AND ANY MISCELLANEOUS MATERIALS NEEDED TO COMPLETE THE REPAIRS TO BE PAID FOR UNDER ITEM NO. 602-10 01, STRUCTURAL STEEL

> STATE OF TENNESSEE DEPARTMENT OF TRANSPORTATION

BRIDGE REPAIR DETAILS STATE ROUTE 14 OVER NONCONNAH CREEK AND RAILROAD BR. NOS. 79-14-7.11 L & R SHELBY COUNTY

7.11R

1994

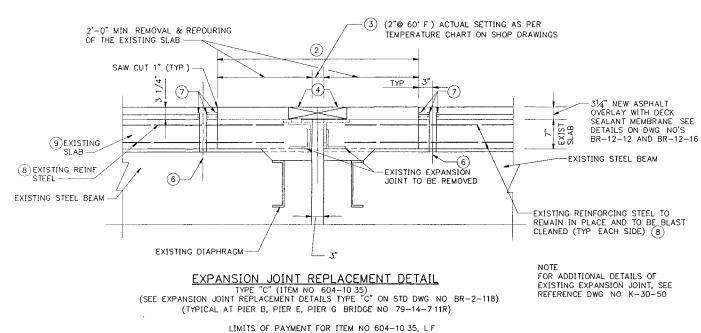

SAW CUT 2" MIN GAP IN EXISTING CONCRETE RAIL (TYP BOTH SIDES) AND SIDEWALK PROVIDE NEW 1/4" SIDEWALK PLATE SEE DETAILS ON REFERENCE DRAWING NO BR-2-115 ALL COSTS SHALL BE INCLUDED IN ITEM NO 604-10 35 EXPANSION JOINT REPAIR (TYPE "C"), LF 40'-0" ROADWAY NEW TYPE "C" STRIP SEAL EXPANSION JOINT EXISTING CONCRETE RAIL AND CROSS SECTION SHOWING LIMITS OF NEW

TYPE "C" STRIP SEAL EXPANSION JOINT

NOTES:

BETWEEN SPANS

SIDEWALK SHALL BE SAW CUT AS NECESSARY TO PROVIDE 3" GAP

- (1) ALL CONCRETE POURS SHALL BE WELL CONSOLIDATED BEHIND AND AROUND THE EXPANSION JOINT STEEL RETAINER
- (2) SEE EXPANSION JOINT REPLACEMENT DETAIL, TYPE "C" ON STANDARD DRAWING NO BR-2-118 FOR FURTHER DETAILS AND NOTES, SEE STANDARD DRAWING NO BR-2-115, BR-2-116, AND SPECIAL PROVISION NO 604S
- (3) SET ALL EXPANSION JOINT REPLACEMENTS 3" (THREE INCHES) AT MID-TEMPERATURE OF 60° F. WITH A TOTAL MOVEMENT REQUIRED OF 6" (SIX INCHES) ACTUAL SETTING AS PER TEMPERATURE CHART ON EXPANSION JOINT SHOP DRAWINGS
- (4) SEE TYPE "X" MEMBRANE RETAINER AND NOTES ON STANDARD DRAWING NO BR-2-116 FOR ADDITIONAL DETAILS AND NOTES, SEE STANDARD DRAWING NOS BR-2-115, AND BR-2-118
- (5) FOR LEVELING BOLT ASSEMBLIES NOT SHOWN, SEE DETAILS ON STANDARD DRAWING NOS BR-2-116 AND BR-2-118 AT STEEL GIRDERS, TYPE "C" EXPANSION SUPPORTS WILL BE REQUIRED (2 PLACES PER EXPANSION JOINT)
- (6) CONTRACTOR TO DRILL A 11/2" # HOLE NEAR FACE OF CURB AT LOW POINT AT EACH SIDE OF BRIDGE
- (7) MASTIC AS RECOMMENDED BY MANUFACTURER OF MEMBRANE SEE STANDARD SPECIFICATIONS, ARTICLE 906 04
- EXTREME CARE SHALL BE TAKEN WHEN REMOVING CONCRETE SLAB SO AS NOT TO DAMAGE THE EXISTING LONGITUDINAL REINFORCING STEEL ALL EXISTING LONGITUDINAL REINFORCING STEEL SHALL BE BLAST CLEANED AND INCORPORATED WITH NEW REINFORCING STEEL ALL WORK MUST MEET WITH FULL SATISFACTION OF THE ENGINEER
- THE CONTRACTOR SHALL BE FULLY RESPONSIBLE FOR SUPPORTING THE PORTIONS OF THE SLAB WHICH ARE NOT TO BE REMOVED WHEN MAKING REPAIRS WHICH REQUIRE THE REMOVAL OF THE END SUPPORT OF A SLAB SPAN DETAILS OF THE SUPPORT SYSTEM SHALL BE SUBMITTED TO THE ENGINEER FOR REVIEW COST OF THE SUPPORT SYSTEM TO BE INCLUDED IN
- (10) CONCRETE FOR ALL EXPANSION JOINT REPAIR AREAS TO BE HIGH EARLY STRENGTH CONCRETE, f'c = 3500 PSI @ 28 DAYS
- COST OF REMOVING CONCRETE FOR THE LIMITS SHOWN, REPOURING WITH HIGH EARLY STRENGTH CONCRETE, EPOXY COATED REINFORCING STEEL, MECHANICAL THREADED CONNECTORS, COUPLER BARS, REMOVAL AND REPLACEMENT OF SIDEWALK PLATES, AND EXPANSION JOINT ASSEMBLIES SHALL BE PAID FOR UNDER ITEM NO 604-10 35, EXPANSION JOINT REPAIR (TYPE "C"), LF
- COST OF INCIDENTALS SUCH AS WELDING, BLAST CLEANING, SAW CUTTING, DRILLING, ETC AND MISCELLANEOUS MATERIALS NECESSARY TO COMPLETE THE INSTALLATION OF THE NEW EXPANSION JOINTS AT PIER B, PIER E, AND PIER G AT BRIDGE NO 79-14-711R. SHALL BE INCLUDED UNDER ITEMS BID ON


DESIGNED BY A J KHAIRI SUPERVISED BY ... CHECKED BY ____T JOHNSON 7 11R

THE CONTRACTOR SHALL USE MECHANICAL THREADED CONNECTORS TO SPLICE TRANSVERSE

REINFORCEMENT BETWEEN CONSTRUCTION OF EACH

PHASE SEE BAR CONNECTOR DETAIL ON DWG NO.

BR-12-10 FOR NOTES AND DETAILS

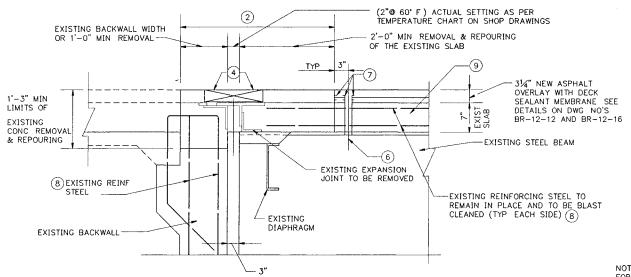


PROJEC	T NO.	YEAR	SHEET NO.
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FOR ADDITIONAL DETAILS OF EXISTING EXPANSION JOINT, SEE REFERENCE DWG NO K-30-50

EXPANSION JOINT REPLACEMENT DETAIL

TYPE "A" (ITEM NO 604-10 32)
(SEE EXPANSION JOINT REPLACEMENT DETAILS TYPE "A" ON STD DWG NO BR-2-117)
(TYPICAL AT ABUTMENT K BRIDGE NO 79-14-7 11R)

LIMITS OF PAYMENT FOR ITEM NO 604-10 32, LF

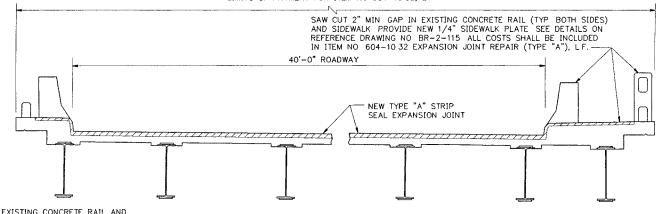

SIDEWALK SHALL BE SAW CUT AS NECESSARY TO PROVIDE 3" GAP BETWEEN SPANS

CROSS SECTION SHOWING LIMITS OF NEW TYPE "A" STRIP SEAL EXPANSION JOINT

THE CONTRACTOR SHALL USE MECHANICAL THREADED CONNECTORS TO SPLICE TRANSVERSE REINFORCEMENT BETWEEN CONSTRUCTION OF EACH PHASE SEE BAR CONNECTOR DETAIL ON DWG NO BR-12-10 FOR NOTES AND DETAILS

NOTES:


- (1) ALL CONCRETE POURS SHALL BE WELL CONSOLIDATED BEHIND AND AROUND THE EXPANSION JOINT STEEL RETAINER
- (2) SEE EXPANSION JOINT REPLACEMENT DETAIL, TYPE "A" ON STANDARD DRAWING NO BR-2-117 FOR FURTHER DETAILS AND NOTES, SEE STANDARD DRAWING NO BR-2-115, BR-2-116, AND SPECIAL PROVISION NO 604S
- SET ALL EXPANSION JOINT REPLACEMENTS 3" (THREE INCHES) AT MID-TEMPERATURE OF 60° F, WITH A TOTAL MOVEMENT REQUIRED OF 6" (SIX INCHES) ACTUAL SETTING AS PER TEMPERATURE CHART ON EXPANSION JOINT SHOP DRAWINGS
- (4) SEE TYPE "X" MEMBRANE RETAINER AND NOTES ON STANDARD DRAWING NO BR-2-116 FOR ADDITIONAL DETAILS AND NOTES, SEE STANDARD DRAWING NOS BR-2-115 AND BR-2-117
- (5) FOR LEVELING BOLT ASSEMBLIES NOT SHOWN, SEE DETAILS ON STANDARD DRAWING NOS BR-2-116, AND BR-2-117
- (6) CONTRACTOR TO DRILL A 11/2"Ø HOLE NEAR FACE OF CURB AT LOW POINT AT EACH SIDE OF BRIDGE
- (7) MASTIC AS RECOMMENDED BY MANUFACTURER OF MEMBRANE SEE STANDARD SPECIFICATIONS, ARTICLE 906 04
- (8) EXTREME CARE SHALL BE TAKEN WHEN REMOVING CONCRETE SLAB SO AS NOT TO DAMAGE THE EXISTING LONGITUDINAL REINFORCING STEEL ALL EXISTING LONGITUDINAL REINFORCING STEEL SHALL BE BLAST CLEANED AND INCORPORATED WITH NEW REINFORCING STEEL ALL WORK MUST MEET WITH FULL SATISFACTION OF THE ENGINEER
- (9) THE CONTRACTOR SHALL BE FULLY RESPONSIBLE FOR SUPPORTING THE PORTIONS OF THE SLAB WHICH ARE NOT TO BE REMOVED WHEN MAKING REPAIRS WHICH REQUIRE THE REMOVAL OF THE END SUPPORT OF A SLAB SPAN DETAILS OF THE SUPPORT SYSTEM SHALL BE SUBMITTED TO THE ENGINEER FOR REVIEW COST OF THE SUPPORT SYSTEM TO BE INCLUDED IN ITEMS BID ON
- (10) CONCRETE FOR ALL EXPANSION JOINT REPAIR AREAS TO BE HIGH EARLY STRENGTH CONCRETE, I'C = 3500 PSI @ 28 DAYS
- (i) COST OF REMOVING CONCRETE FOR THE LIMITS SHOWN, REPOURING WITH HIGH EARLY STRENGTH CONCRETE, EPOXY COATED REINFORCING STEEL, MECHANICAL THREADED CONNECTORS, COUPLER BARS, REMOVAL AND REPLACEMENT OF SIDEWALK PLATES, AND EXPANSION JOINT ASSEMBLIES SHALL BE PAID FOR UNDER ITEM NO 604-1032, EXPANSION JOINT REPAIR (TYPE "A"), LF
- (2) COST OF INCIDENTALS SUCH AS WELDING, BLAST CLEANING, SAW CUTTING, DRILLING, ETC AND MISCELLANEOUS MATERIALS NECESSARY TO COMPLETE THE INSTALLATION OF THE NEW EXPANSION JOINTS AT ABUTMENT K BRIDGE NO 79-14-711R, SHALL BE INCLUDED UNDER ITEMS BID ON

STATE OF TENNESSEE DEPARTMENT OF TRANSPORTATION

BRIDGE REPAIR DETAILS STATE ROUTE 14 OVER NONCONNAH CREEK AND RAILROAD BR NOS. 79-14-711 L & R SHELBY COUNTY

7.11R

1994

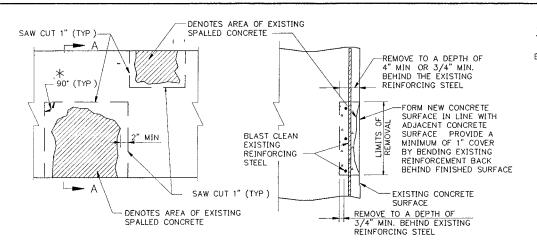

SPALL REPAIRS (BENTS/PIERS)

BRIDGE NO 79-14-7 11L

LOCATIONS	AREA (SQ FT)
BENT 2 BENT 3 BENT 4 BENT 5 BENT 6 BENT 7 BENT 8 BENT 9 BENT 10 BENT 11 BENT 12 BENT 13 PIER 1	43 68 29 6 32 22 22 23 73 18 40 57
TOTAL	512

EXISTING CONCRETE CRACKS TO BE EPOXY INJECTED

EPOXY INJECTION DETAIL

BR NO 79-14-7 11L BENT 1 SHOWN

BE AS PER JOINT MANUFACTURER

PROJECT NO. YEAR SHEET NO. 79022-4221-04 1994 REVISIONS BRIEF DESCRIPTION

SPALL REPAIR DETAILS

NOTES

* SAW CUT EXISTING CONCRETE SO AS TO OBTAIN A RECTANGULAR AREA

COST OF CUITING, REMOVING SPALLED CONCRETE, BLAST CLEANING, NEW EPOXY GROUT, LABOR, AND ANY MISCELLANEOUS MATERIALS NECESSARY TO COMPLETE THE REPAIRS AS SHOWN SHALL BE INCLUDED IN ITEM NO

APPROXIMATELY 541 SQ FOR LOCATIONS SEE TABLES THIS SHEET FOR LOCATONS OTHER LOCATIONS MAY BE DESIGNATED BY ENGINEER

PATCHING MATERIAL SHALL BE POLYMER-MODIFIED CEMENTITIOUS NON-SAG, PATCHING MATERIAL, SUCH AS SIKATOP 122 OR EQUAL

SPALL REPAIRS (GIRDERS)

Br	IDGE NO	79-14-	-/ IIL	
SPA		IRDER (NO)	AREA (SQ F	
15 16 17	,	A E A H	2 2 2 2	

TOTAL

8

SPALL REPAIRS (HANDRAILS)

BRIDGE NO	79-14-7 11L
LOCATION	AREA
	(SQ FT)
SPAN 14	11

SPALL REPAIRS (DIADLIDACMO)

(DIAPHRAGMS)				
RIDGE NO 79-14-7 11L				
LOCATION	AREA (SQ FT)			
BENT 4	10			


NOTES

ALL CRACKS SMALLER THAN 1/4" SHALL BE INJECTED WITH AN APPROVED EPOXY RESIN ADHESIVE ALL CRACKS 1/4" OR LARGER SHALL BE INJECTED WITH AN APPROVED EPOXY RESIN ADHESIVE OF THE GEL TYPE.

EXTREME CAUTION SHALL BE TAKEN WHEN SELECTING A PRESSURE NECESSARY TO COMPLETE THE EPOXY INJECTION CRACK REPAIR SO NOT TO DAMAGE THE STRUCTURE BY CAUSING ADDITIONAL CRACKING IF ADDITIONAL DAMAGE OCCURS, THE CONTRACTOR SHALL BEAR FULL RESPONSIBILITY ALL EPOXY INJECTION WORK SHALL MEET THE FULL APPROVAL OF THE ENGINEER

ALL EPOXY INJECTION CONTRACTORS AND/OR SUBCONTRACTORS SHALL BE APPROVED BY TENNESSEE DEPARTMENT OF TRANSPORTATION, DIVISION OF MATERIALS AND TESTS


COST OF ALL LABOR AND MISCELLANEOUS MATERIALS NECESSARY TO COMPLETE THE EPOXY INJECTION REPAIRS TO EXISTING CONCRETE CRACKS SHALL BE INCLUDED UNDER ITEM NO 604-1062, EPOXY INJECTION REPAIRS (COMPLETE AND IN PLACE) L F

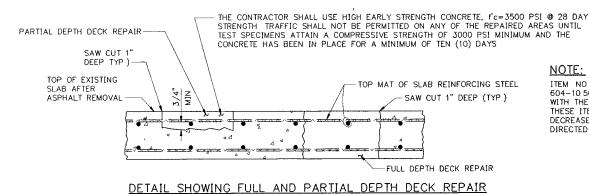

REMOVE CONCRETE IN ALL DELAMINATED AREAS TO A DEPTH OF 3/4" BELOW THE TOP BAR OF THE TOP MAT OF REINFORCING STEEL ALL REINFORCING STEEL IN AREAS OF DECK
REPAIR SHALL BE BLAST CLEANED AREAS OF CONCRETE REMOVAL SHALL BE DESIGNATED
BY PERSONNEL FROM THE HEADOUARTERS, BRIDGE INSPECTION AND REPAIR OFFICE DECK
REPAIR WILL BE PAID FOR UNDER ITEM NO. 604–10.50, BRIDGE DECK REPAIR (PARTIAL DEPTH OF SLB), AND ITEM NO 604-10 30, BRIGGE DECK REPAIR (FULL DEPTH OF SLAB) DURING PARTIAL DEPTH REPAIRS, SHOULD DETERIORATED CONCRETE BE ENCOUNTERED WHICH APPEARS TO RUN FULL DEPTH IN THE SLAB, THE ENGINEER MAY DESIGNATE THESE AREAS TO BE REPAIRED UNDER ITEM NO 604-10 30 POWER DRIVEN HAND TOOLS USED FOR THE REMOVAL OF UNSOUND CONCRETE IN MAKING PARTIAL DEPTH REPAIRS ARE SUBJECT TO THE FOLLOWING RESTRICTIONS 1) PNEUMATIC HAMMERS HEAVIER THAN NOMINAL 35 POUND CLASS SHALL NOT BE USED, 2) CHIPPING HAMMERS OF THE 15 POUND CLASS SHALL BE USED TO REMOVE CONCRETE FROM BENEATH ANY

NOTE:

ITEM NO 604-10.30 AND 604-10 50 SHALL BE BID WITH THE CONTINGENCY THAT THESE ITEMS MAY BE INCREASED. DECREASED, OR ELIMINATED AS DIRECTED BY THE ENGINEER

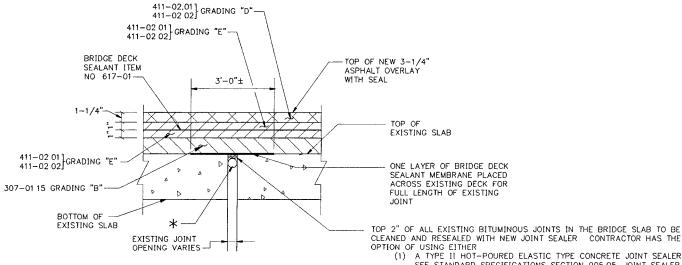

EXISTING BITUMINOUS JOINT REPAIR DETAIL

ACROSS EXISTING DECK FOR FULL LENGTH OF EXISTING TOP 2" OF ALL EXISTING BITUMINOUS JOINTS IN THE BRIDGE SLAB TO BE

(1) A TYPE II HOT-POURED ELASTIC TYPE CONCRETE JOINT SEALER

SEE STANDARD SPECIFICATIONS SECTION 905 05, JOINT SEALER

(2) A COLD POUR SINGLE COMPONENT JOINT SEALER AS APPROVED BY THE DIVISION OF MATERIALS AND TEST

COST OF JOINT CLEANING AND SEALING TO BE INCLUDED UNDER ITEM NO 617-01 (BRIDGE DECK SEALANT) THE SEALER SHALL EXTEND UP AND ACROSS THE CURB OR SIDEWALK AREA TO THE OUTER EDGE OF THE BRIDGE SLAB


THE MOVEMENT GAP SHALL BE CAULKED WITH A BACKER ROD OF SUITABLE DIAMETER THE ROD SHALL BE PLACED AT A DEPTH TO ENSURE THE CONCRETE WIDTH/DEPTH RATIO OF THE EXISTING BRIDGE JOINT SYSTEM BACKER ROD AND CAULK SHALL


STATE OF TENNESSEE DEPARTMENT OF TRANSPORTATION

BRIDGE REPAIR DETAILS STATE ROUTE 14 OVER NONCONNAH CREEK AND RAILROAD BR. NOS. 79-14-7.11 L & R SHELBY COUNTY

1994

DESIGNED BY A J KHAIRI
DRAWN BY A J KHAIRI
SUPERVISED BY I JOHNSON
CHECKED BY T JOHNSON

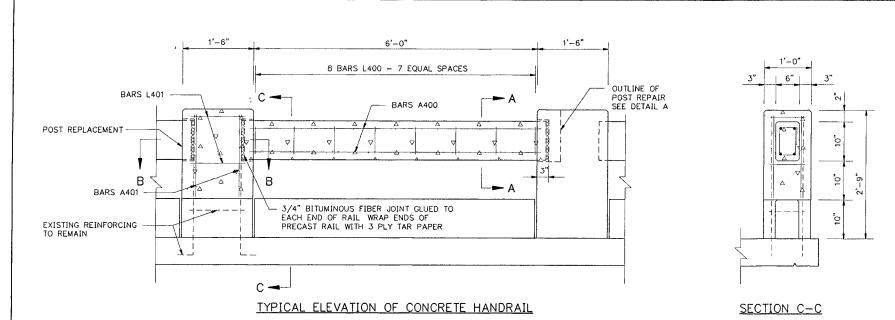

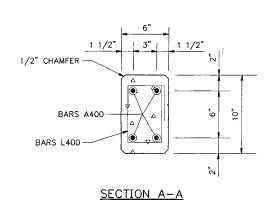

SECTION B-B

NOTES.


ALL COSTS ASSOCIATED WITH THE REMOVAL AND REPLACEMENT OF THE CONCRETE HANDRAIL AND POST AND POST REPAIR SHALL BE INCLUDED IN THE COST FOR ITEM NO 604-10 06, CONCRETE HANDRAIL REPAIR, LF MEASUREMENT SHALL BE BETWEEN CENTER LINES OF POSTS ON EACH SIDE OF RAIL TO BE REPLACED

CONCRETE FOR NEW HANDRAIL AND POST SHALL BE HIGH EARLY STRENGTH CONCRETE, f'c=3,500 PSI AT 28 DAY STRENGTH


REMOVE AND REPLACE ONE RAIL EACH ON SPANS 3 AND 6, REPLACE ONE MISSING RAIL EACH ON SPANS 4 AND 6, REPLACE ONE POST ON SPAN 9, AS WELL AS OTHER LOCATIONS AS MAY BE DESIGNATED BY ENGINEER

POST REPAIR WHERE NOTED, POST REPAIR NECESSARY TO INSTALL PRECAST CONCRETE GUARDRAIL SECTIONS, AND POST REPLACEMENT IN SPAN 6 WILL NOT BE PAID FOR SEPARATELY ALL COSTS SHALL BE INCLUDED IN THE COST FOR ITEM NO 604-10 06, CONCRETE HANDRAIL REPAIR, L F

ALL DIMENSIONS SHALL BE FIELD VERIFIED BY THE CONTRACTOR PRIOR TO ORDERING REINFORCEMENT

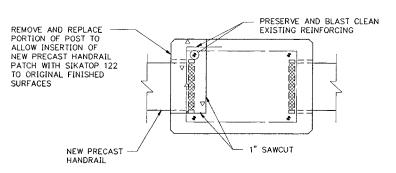


<u>DETAIL A</u> <u>PLAN OF POST REPAIR</u>

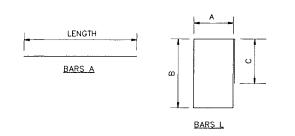

BAR	SIZE	NO REQD		LENGTH			
			Α	В	С	D	LENGIA
A400	T 4	4	KAIL	AND PO	ST REINF	URCEN	6'-2"
A401	4	4					1'-9"
	4	8	4"	7"	4 1/2"		2'-2 1/2"
_400			9"	1'-2"	4 1/2"		4'-2 1/2"

7.11L

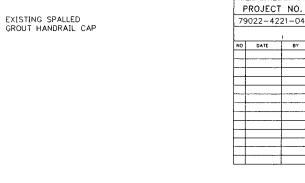


79022-4221-04 1994 REVISIONS NO DATE BY BRIEF DESCRIPTION

YEAR

SHEET NO.

SECTION D-D

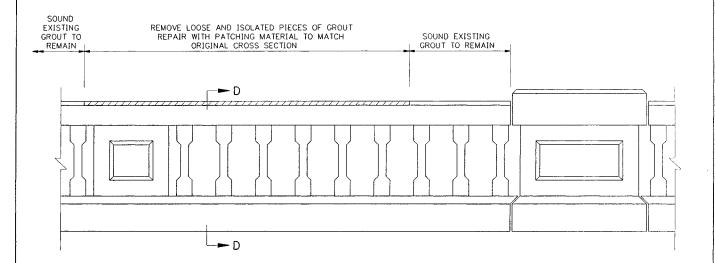

TYPICAL ELEVATION OF CONCRETE HANDRAIL

NOJES

ALL COSTS ASSOCIATED WITH REPAIRING THE HANDRAIL AT BRIDGE NO 79-14-711L INCLUDING COST OF REMOVING SPALLED CONCRETE, NEW PATCHING MATERIAL, LABOR, AND ANY MISCELLANEOUS MATERIALS NECESSARY TO COMPLETE THE REPAIRS AS SHOWN SHALL BE INCLUDED IN ITEM NO 604-1054, CONCRETE REPAIRS, SF SEE DWG NO BR-12-12 FOR SPALL REPAIR DETAILS

APPROXIMATELY 11 SQ FT OF SPALL REPAIR ALONG ORIGINAL HANDRAIL ON BRIDGE 79-14-711L, AS WELL AS OTHER LOCATIONS AS MAY BE DESIGNATED BY ENGINEER SEE DWG NO BR-12-5 FOR SPAN LOCATIONS

PATCHING MATERIAL SHALL BE POLYMER-MODIFIED CEMENTITIOUS PATCHING MATERIAL, SUCH AS SIKATOP 122 OR EQUAL

STATE OF TENNESSEE
DEPARTMENT OF TRANSPORTATION


BRIDGE REPAIR DETAILS
STATE ROUTE 14 OVER
NONCONNAH CREEK AND RAILROAD
BR. NOS 79-14-711 L & R
SHELBY COUNTY

1994


94

AJ/AJ SHLB-13 911738\003 2/3/94 2 1=1

 7.11R

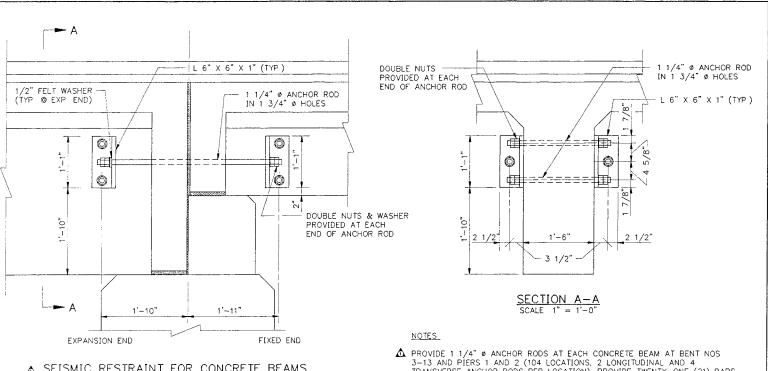

 ∆ SEISMIC RESTRAINT FOR CONCRETE BEAMS (BENT NO 5 SHOWN, OTHER BENTS ARE SIMILAR)
SCALE 1" = 1'-0"

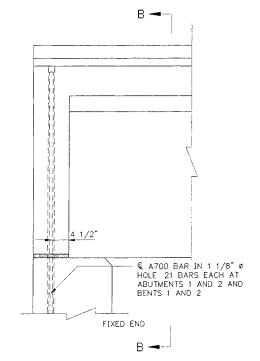

A SEISMIC RESTRAINT FOR CONCRETE BEAMS 1 SHOWN, ABUT 2 AND BENTS 1 & 2 SIMILAR)
SCALE 1" = 1'-0"

BAR A700


BAR A700 IN 1 1/8" Ø HOLE, 3 BARS PER BAY (TYP)

<u>↑ SECTION B−B</u>
(SHOWING DIAPHRAGM AT ABUTMENTS AND BENTS 1 AND 2)


A PROVIDE 1 1/4" Ø ANCHOR RODS AT EACH CONCRETE BEAM AT BENT NOS 3-13 AND PIERS 1 AND 2 (104 LOCATIONS, 2 LONGITUDINAL AND 4 TRANSVERSE ANCHOR RODS PER LOCATION) PROVIDE TWENTY-ONE (21) BARS A700 EACH AT ABUTMENTS 1 AND 2, BENT NOS 1 AND 2 (84 TOTAL)

HOLES FOR GROUTED BARS SHALL BE DRILLED WITH HIGH SPEED DRILL THE DRILL BIT SHALL BE CAPABLE OF DRILLING THROUGH REINFORCING BARS AND CONCRETE THE HORIZONTAL DRILLED HOLE SHALL BE 1/2" IN DIAMETER CONCRETE THE HORIZONTAL DRILLED HOLE SHALL BE 1/2 IN DIAMETER LARGER THAN THE BAR, CLEANED, PACKED WITH NON-SHRINK GROUT, AND THE BAR DRIVEN TO ITS SEAT THE VERTICAL DRILLED HOLE SHALL BE DRILLED 1/4" IN DIAMETER LARGER THAN THE BAR, CLEANED, PACKED WITH NON-SHRINK GROUT, AND THE BAR DRIVEN TO ITS SEAT A LIST OF APPROVED GROUTS MAY BE OBTAINED FROM THE TENNESSEE DEPARTMENT OF TRANSCHOOL TITON DIVISION OF MATERIAL AND TEST. TRANSPORTATION DIVISION OF MATERIAL AND TESTS

- ⚠ STRUCTURAL STEEL ANGLES FOR SEISMIC RESTRAINT FOR CONCRETE BEAMS SHALL BE GRADE 36 STEEL 1 1/4" Ø ANCHOR RODS SHALL BE ASTM A325
- ⚠ ALL COSTS ASSOCIATED WITH FURNISHING AND INSTALLING BARS A700 SHALL BE PAID FOR UNDER ITEM NO 604-03 21, BRIDGE JOINT SEISMIC MODIFICATION, EACH
- ⚠ ALL COSTS ASSOCIATED WITH FURNISHING AND INSTALLING 1 1/4" Ø ANCHOR RODS AND ANGLES SHALL BE PAID FOR UNDER ITEM NO 604-03 21, BRIDGE JOINT SEISMIC MODIFICATION, EACH

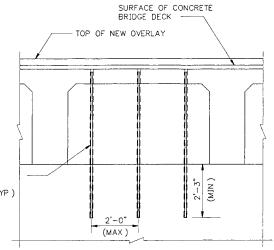

SCALE 1/2" = 1'-0"

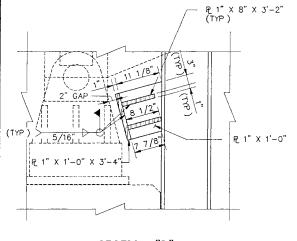

<u>SECTION "D"</u> SCALE. 1" = 1'-0"

NOTES


CONTRACTOR SHALL SUBMIT SHOP DRAWINGS TO HEADQUARTERS, BRIDGE INSPECTION AND REPAIR OFFICE FOR APPROVAL, PRIOR TO SHOP FABRICATION

ALL NEW STRUCTURAL STEEL FOR SEISMIC RESTRAINT FOR TRUSS SPAN SHALL BE GRADE $50\,$

ALL NEW STRUCTURAL STEEL MEMBERS AND PLATES SHALL RECEIVE A SHOP PRIMER COAT OF 2 1/2 MILS MINIMUM DRY FILM THICKNESS OF INORGANIC ZINC

HOLES IN CONCRETE SHALL BE DRILLED WITH A HIGH SPEED DRILL THE DRILL BIT SHALL BE CAPABLE OF DRILLING THROUGH REINFORCING BARS AND CONCRETE

ALL COSTS ASSOCIATED WITH SEISMIC RESTRAINT AT THE TRUSS SPAN SHALL BE PAID FOR UNDER ITEM NO 604-0321, BRIDGE JOINT SEISMIC MODIFICATION, EACH

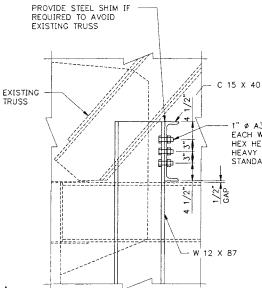

PROJECT NO. YEAR SHEET NO. 79022-4221-04 1994 REVISIONS

NO DATE BY BRIEF DESCRIPTION


6/2/94 NDT CHANGED SEISMIC DETAILS FOR CONCRETE

" Ø A325 BOLT EACH WITH HEAVY HEX HEADS AND ONE HEAVY HEX NUT AND STANDARD WASHER

> SPECIAL NOTE TO CONTRACTOR
> DIMENSIONS SHOWN ARE BASED ON ORIGINAL DESIGN DRAWINGS AND ARE APPROXIMATE CONTRACTOR SHALL FIELD MEASURE EXISTING BEARINGS AND SIZE PLATES AS REQUIRED TO GET 2" GAP SHOWN

DETAIL

NOTE HOLES IN ANCHOR PLATES AND W12X87 BEAMS SHALL NOT BE DRILLED UNTIL HOLES ARE DRILLED THROUGH THE CONCRETE CAP

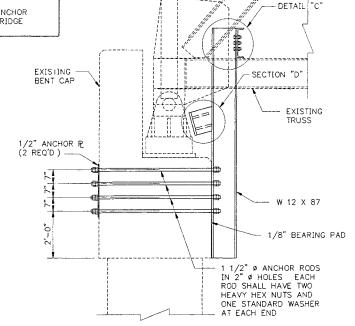

END ELEVATION

SEISMIC RESTRAINT FOR TRUSS SPAN

(BENT NO 1 SHOWN, BENT NO 2 IS SIMILAR) SCALE 1/2" = 1'-0"

EXISTING SEE DETAIL "C EXISTING BENT CAP ______ P 1" X 1'-0" X 3'-4" SEE SECTION "D" ollo Il Olle 1/2" ø ANCHOR ROD 00 ه اه W 12 X 87 3'-3" (TYP) STATE OF TENNESSEE DEPARTMENT OF TRANSPORTATION

FRONT ELEVATION

BRIDGE REPAIR DETAILS STATE ROUTE 14 OVER NONCONNAH CREEK AND RAILROAD BR NOS 79-14-711 L & R SHELBY COUNTY

1994


BR-12-14


DESIGNED BY N TINER


DRAWN BY N TINER

SUPERVISED BY T JOHNSON

CHECKED BY T JOHNSON

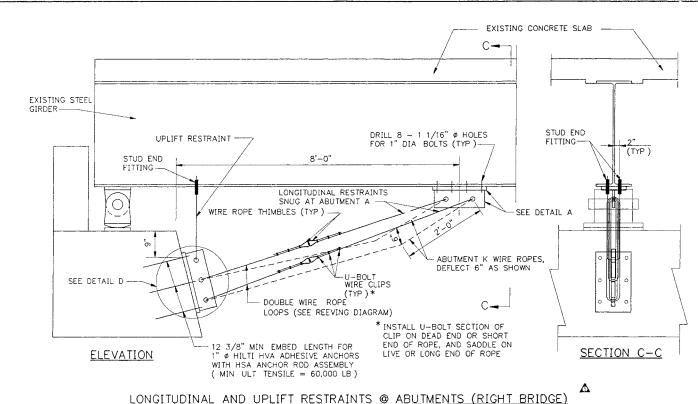

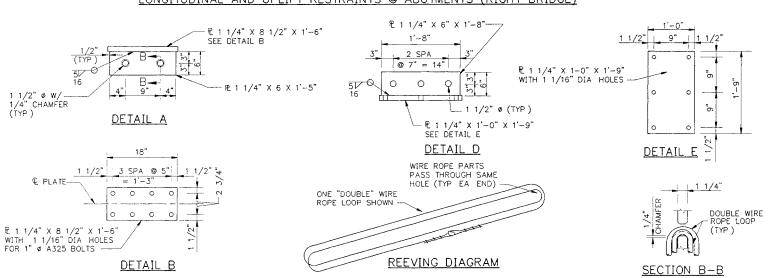

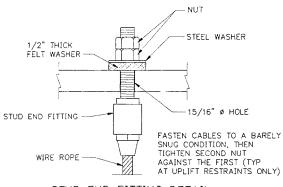

STUD END FITTING DETAIL

GENERAL NOTES

WIRE ROPE SHALL BE 5/8" GALVANIZED IMPROVED PLOW STEEL WIRE ROPE, FIBER CORE, 30,000 LBS BREAKING STRENGTH

ROPE FITTINGS SHALL BE 7/8" THREADED END, FORGED, HEAVY DUTY STUD END FITTINGS FOR 5/8" WIRE ROPE, GALVANIZED STEEL FITTING SHALL MEET OR EXCEED CABLE BREAKING STRENGTH

EXPANSION ANCHORS SHALL BE SIMILAR AND EQUAL TO HILTI KWIK BOLT II 12" LONG ANCHORS, 28000 LBS ULTIMATE LOAD CAPACITY


WIRE ROPE CLIPS SHALL BE FORGED STEEL, GALVANIZED, U-BOLT WIRE ROPE CLIPS

WIRE ROPE THIMBLES SHALL BE GALVANIZED CARBON STEEL STANDARD PATTERN THIMBLES FOR $5/8^\circ$ WIRE ROPE

WIRE ROPES AND FITTINGS MAY BE OBTAINED FROM McMASTER-CARR SUPPLY COMPANY, (404) 346-700, OR OTHERS

ALL COSTS ASSOCIATED WITH THE INSTALLATION OF LONGITUDINAL AND UPLIFT RESTRAINTS ON ONE BEAM LINE AT ABUTMENTS SHALL BE INCLUDED UNDER ITEM NO 604-03 21, BRIDGE JOINT SEISMIC MODIFICATION, EACH THIS WILL INCLUDE THE COST OF WIRE ROPES, ROPE FITTINGS, ROPE CLIPS, WIRE ROPE THIMBLES, STEEL PLATES, WELDING, DRILLING, 1" DIA EXPANSION ANCHORS, AND ALL LABOR AND MATERIALS NECESSARY TO INSTALL THE LONGITUDINAL JOINT RESTRAINTS AS SHOWN ON THESE DETAILS

THE UPLIFT AND LONGITUDINAL RESTRAINTS ARE REQUIRED AT ABUT A AND K EIGHT RESTRAINTS ARE REQUIRED FOR EACH ABUTMENT

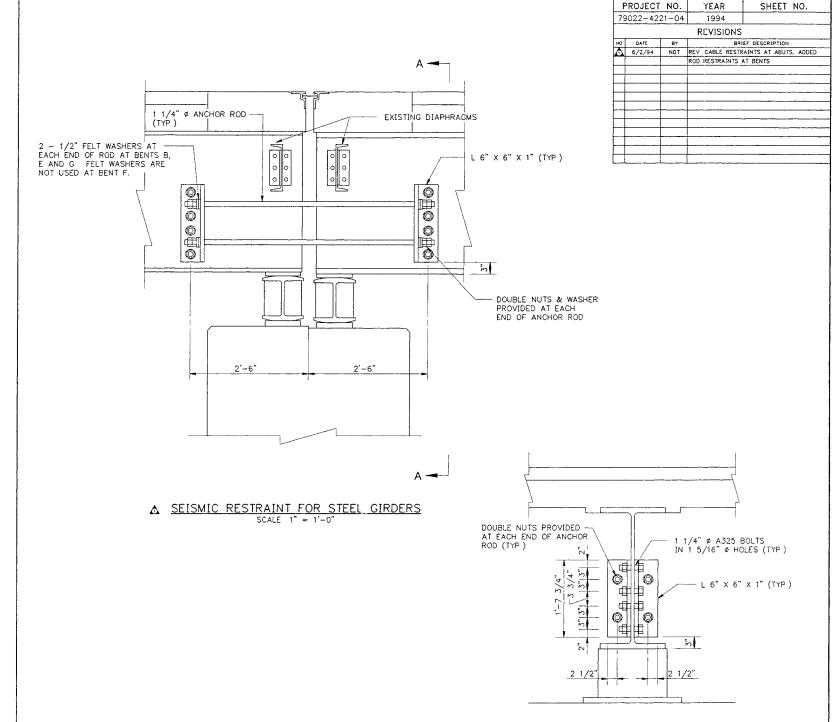

♠ NOTES


PROVIDE 1 1/4" ϕ anchor rods at each steel girder at Piers B, E, F, and G (32 Locations, 4 Longitudinal anchor rods per Location)

STRUCTURAL STEEL ANGLES FOR SEISMIC RESTRAINT FOR STEEL GIRDERS SHALL BE GRADE 36 STEEL 1 1/4" $\mathbb Q$ ANCHOR RODS SHALL BE A325

ALL COSTS ASSOCIATED WITH FURNISHING AND INSTALLING 1 1/4" Ø ANCHOR RODS, BOLTS AND ANGLES SHALL BE PAID FOR UNDER ITEM NO 604-03 21, BRIDGE JOINT SEISMIC MODIFICATION, EACH

STATE OF TENNESSEE DEPARTMENT OF TRANSPORTATION

BRIDGE REPAIR DETAILS
STATE ROUTE 14 OVER
NONCONNAH CREEK AND RAILROAD
BR NOS 79-14-711 L & R
SHELBY CCUNTY

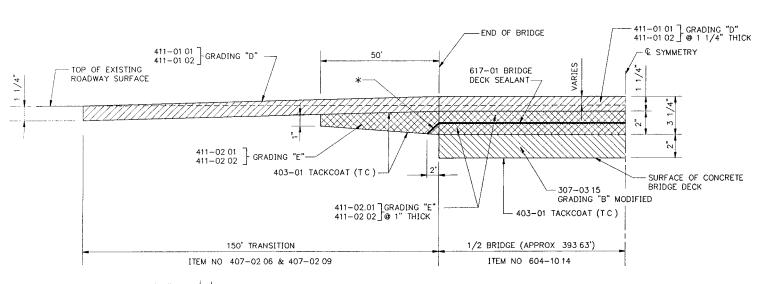

* BRIDGE DECK SEALANT TO EXTEND 2'-0" BEYOND END OF BRIDGE


COST OF ALL LABOR AND MATERIALS FOR PLACING BRIDGE DECK SEALANT FOR THE FULL WIDTH AND LENGTH OF BRIDGE, 2' PAST THE BEGINNING AND END OF BRIDGE, AND 3' WIDTH AT REQUIRED TRANSVERSE JOINTS, SHALL BE INCLUDED UNDER ITEM NO 617—01 BRIDGE DECK SEALANT, SY

BRIDGE DECK SEALANT AND AND PAVEMENT TRANSITION PROFILE (BRIDGE NO 79-14-7 11L) SCALE NONE

NOTES.

SEE SECTION 617 AND 906 OF THE TENNESSEE STANDARD SPECIFICATION FOR ROAD AND BRIDGE CONSTRUCTION

ASPHALT FOR TEMPORARY RAMPS WILL BE PAID FOR AS ITEM NO 411-01

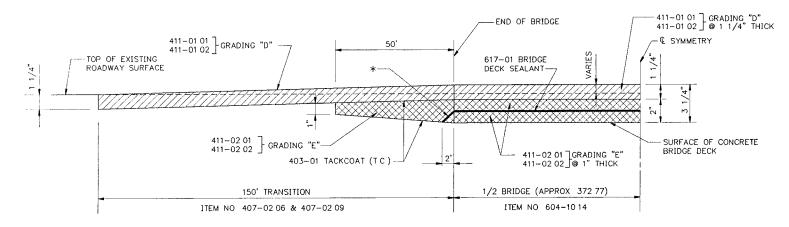

* BRIDGE DECK SEALANT TO EXTEND 2'-0" BEYOND END OF BRIDGE AT FIXED END (ABUTMENT A) OMIT THE 2'-0" LENGTH OF BRIDGE DECK SEALANT IN THE PAVING TRANSITION AREA AT EXPANSION END (ABUTMENT K)


COST OF ALL LABOR AND MATERIALS FOR PLACING BRIDGE DECK SEALANT FOR THE FULL WIDTH AND LENGTH OF BRIDGE, 2'-O" PAST ABUTMENT A, SHALL BE INCLUDED UNDER ITEM NO 617-01 BRIDGE DECK SEALANT, S Y


BRIDGE DECK SEALANT AND AND PAVEMENT TRANSITION PROFILE (BRIDGE NO 79-14-7 11R) SCALE. NONE

MASTIC AS RECOMMENDED BY—
MANUFACTURER OF MEMBRANE
SEE STANDARD SPECIFICATION
ARTICLE 906 04

OVERLAY DETAIL AT GUARDRAIL

FACE OF EXISTING

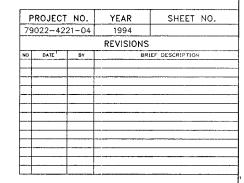

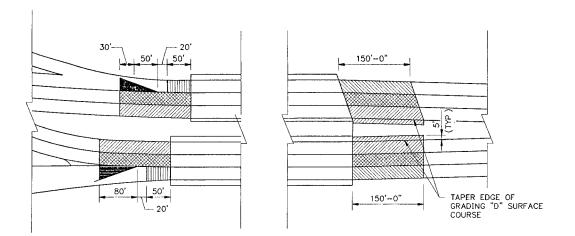

PLAN OF PAVEMENT TRANSITION AT BRIDGE ENDS (BRIDGE NOS 79-14-711 L & R) SCALE NONE

LEGEND

GRADING "D" & GRADING "E" TO BE COMPLETED DURING PHASE I

GRADING "D" & GRADING "E" TO BE COMPLETED DURING PHASE II


GRADING "D" & GRADING "E" TO BE COMPLETED DURING PHASE III

GRADING "E" ONLY TO BE COMPLETED DURING PHASE III


TEMPORARY RAMP PROVIDED DURING PHASE III

STATE OF TENNESSEE
DEPARTMENT OF TRANSPORTATION

BRIDGE REPAIR DETAILS
STATE ROUTE 14 OVER
NONCONNAH CREEK AND RAILROAD
BR. NOS 79-14-7.11 L & R
SHELBY COUNTY

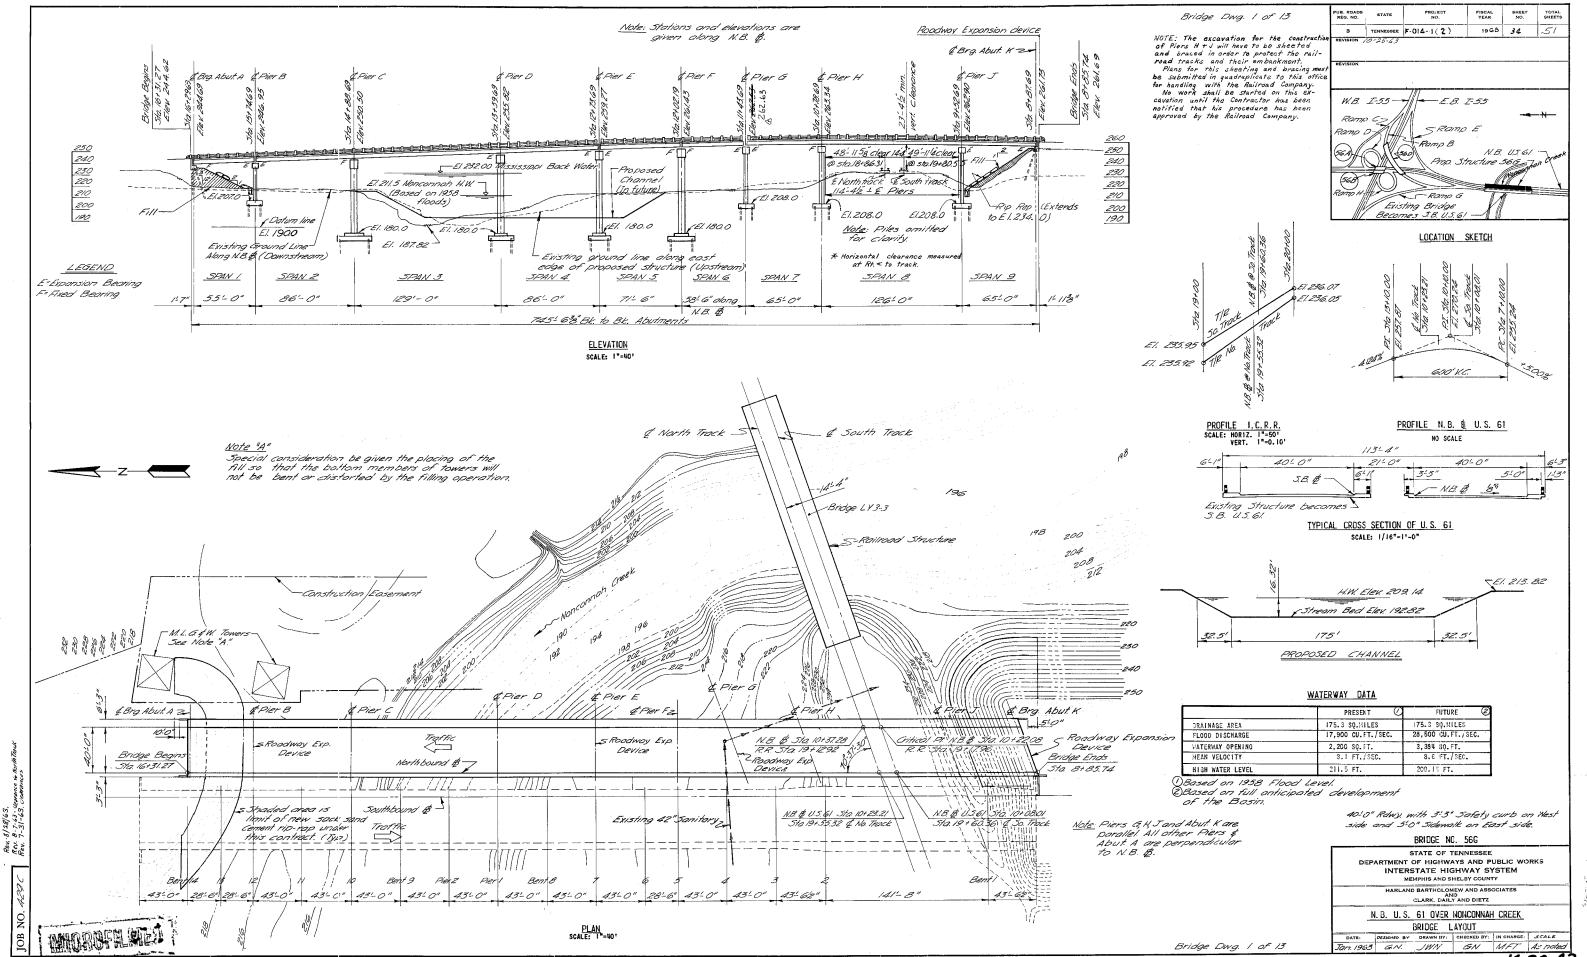

K-30-42

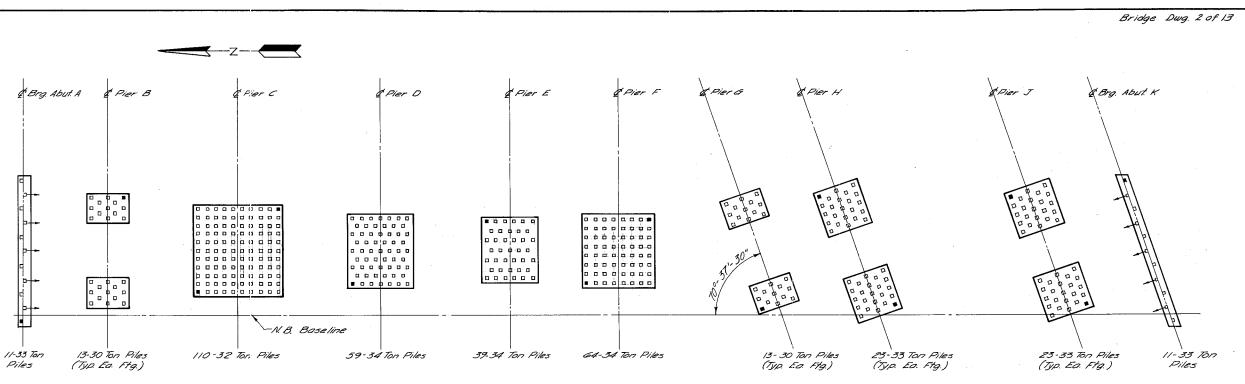

Note: Piers G. H. J and Abut K are parallel.

pendicular to N.B. B.

All other Piers and Abut A are per-

PILE LOCATION SKETCH

NO SCALE:

SUMMARY OF ESTIMATED QUANTITIES

ITEM	DRY EXCAVATION	WET EXCAVATION	CLASS A CONCRETE ②	STEEL BAR REINFORCEMENT	PRECAST CONCRETE PILE SIZE I	TEST PILES	STRUCTURAL STEEL	CON CRETE HANDRAIL @	GRAY IRON CASTINGS	6" WROUGHT IRON PIPE	PIP RAP	
UNIT	CU.YDS.	CU.YDS.	CU.YDS.	LBS.	LIN.FT.	LIN.FT.	Lump Sum	LIN.FT.	LBS.	LIN.FT.	CU.YDS.	
SUPERSTRUCTURE			930.3	220,040								
SUBSTRUCTURE												
ABUTMENT A			30.9	2,690							229	
PIER B	188		102.0	15,260								
PIER C	1188	534	309.4	85,230								
PIER D	199	323	236.7	64,650								-
PIER E	474	229	221.1	3 9,250								
PIER F	729	3:51	255.1	47,090								
PIER G	188	-	120.1	19,120								
PIER H	546		151.7	48,160								
PIER J	498		151.4	48,160								
ABUTMENT K			41.9	3,520							164	
TOTAL	4,010	1,437	2,550.6	593, 170	10,600	560	<i>Гитр Бит</i>	1491	4400	253	393	

THE COST OF FURNISHING, ERECTING AND PAINTING 472,370 STRUCTURAL STEEL SHALL BE A LUMP SUM AND SHALL INCLUDE 273,640 BEAMS, 37,060 BEARINGS, 100,640 DIAPHRAGMS AND SPLICES, 13,960 EXPANSION DEVICES, 3,150 SHEAR CONNECTORS, AND 24,900 HIGH STRENGTH STEEL BOLTS, AND ALL OTHER INCIDENTALS NECESSARY FOR COMPLETING THE WORK.

① ALL EXCAVATION SHALL BE CONSIDERED WET OR DRY (BRIDGES)
② ALL JOINT MATERIALS SHALL BE CONSIDERED INCIDENTAL TO CLASS A CONCRETE FOR PAYMENT.

4) 1491 LIN. FT. OF HANDRAIL INCLUDES 668 CU. YDS. OF CONC. AND 12,270 LBS. OF REIN. STEEL.

BRIDGE LAYOUT	1
GENERAL NOTES & QUANTITIES	2
ABUTMENT A	3
ABUTMENT K	. 4
PIERS.B, G, H & J	5
PIERS C & D	6
PIERS E & F	. 7
STEEL FRAMING PLAN	8
EXPANSION DEVICE & DIAPHRAGM DETAILS	. 9
BEARINGS & SPLICE DETAILS	10
SUPERSTRUCTURE SLAB SPANS 1-5	11
SUPERSTRUCTURE SLAB SPANS 6-9	12
SUPERSTRUCTURE SLAB DETAILS & HANDRAIL & DRAIN.	AGE DETAILS13
STD. HANDRAIL DETAILS, TENN STD. H-5-110 SHT.	0F
STD. PILE DETAILS, TENN STD. H-5-III SHT. OF	

DESIGN STRESSES

CAST-IN-PLACE CONCRETE: f'c = 3000 psi fc = 1200 PSI n = 10

H20-S16-44

fs = 20,000 PSI

DWG. NO.

LOADING:

LIST OF DRAWNGS

REINFORCING STEEL: (INTERMEDIATE GRADE) REVISION

PROJECT NO.

3 TENNESSEE F-014-1 (2)

REVISION 10-25-63-11-14-63.

FISCAL YEAR SHEET NO.

1963 35 5/

GENERAL NOTES

PUB. ROADS REG. NO.

- 1. SPECIFICATIONS: STANDARD ROAD AND BRIDGE SPECIFICATIONS OF THE TENNESSEE DEPARTMENT OF HIGHWAYS & PUBLIC WORKS.
- 2, <u>CAST-IN-PLACE CONCRETE</u> SHALL BE CLASS A. SEE SPECIFICATIONS.
- SPECIFICATIONS.

 3. REINFORCING STEEL: SEE SPECIFICATIONS, INTERMEDIATE OR HARD GRADE SHALL BE USED. ALL DIMENSIONS ARE TO THE CENTER OF BARS UNLESS OTHERWISE INDICATED. ALL BARS SHALL HAVE A WINIHUM COVER OF 3 INCHES IN FOOTINGS, 2 INCHES IN ABUTWENT WALLS, PIER CAPS AND COLUMNS, AND I INCH IN SLABS, EXCEPT AS OTHERWISE NOTED.
- 4. NOTES ON DETAILING REINFORGING: STEEL: STANDARD
 ABBREVIATIONS: USED: THROUGHOUT.

 FF FAR FACE; NF NEAR: FACE; EF EACH FACE
 EXAMPLE: 8-F5Ha: 30:12
 8-NUMBER OF BARS; #5 BAR SIZE
 Ma-POSITION AND LOCATION; 12-SPACING.
 3-THIRD BAR IN SERIES
- 5. PILES SHALL BE PRECAST OR PRESTRESSED CONCRETE AS SHOWN ON TENNESSEE STANDARD DWG. H-5-111. MINIMUM BEARING CAPACITY SHALL BE AS SHOWN ON BRIDGE DWG. 2.
- DERNING GRANTII GHALL BE AS SHOWN UN BKIDGE UNG. 2.

 5. TEST PILES: BEFORE ANY PILES ARE ORDERED TEST PILES SHALL BE DRIVEN IN THE LOCATION SHOWN ON BRIDGE DWG. 2. FROM THE RESULTS ALL PILES SHALL BE ORDERED OF SUCH LENGTHS AS TO PROVIDE THE MINIMUM BEARING CAPACITIES SHOWN. TEST PILES SHALL BE DRIVEN IN FINAL LOCATIONS IN FOOTINGS.
- 7. PRESTRESSED CONCRETE PILES: SEE SPECIAL PROVISIONS.
- 8. FILL: ALL FILL SHALL BE PLACED AND COMPACTED BEFORE PILES ARE DRIVEN.
- 9. BRIDGE JOINT SEALER:CLASS A OR B SEE SPECIAL PROVISIONS.
- 10. STRUCTURAL STEEL: SEARING PINSSHALL BESASS.Tom. A-235. ALL OTHER STEEL SHALL BE A-36.
- 11. STUDS: SHALL BE FLUX FILLED. FOR STUDS AND WELDING TO BEAMS SEE THE SPECIAL PROVISIONS.
- 12. UTILITIES: LTIS. INTERDED THAT THE COST OF THE 12"
 DIA. WATER LINE AND ALL INCIDENTAL MATERIAL AND LABOR NECESSARY: FOR THE COMPLETE HISTALLATION OF THIS UTILITY SHALL BE BORNE BY OTHERS AND SHALL MOT BE PAID FOR AS A PART OF THIS CONTRACT.
- THE CONTRACTOR SHALL CO-OPERATE WITH NO ADDITIONAL COMPENSATION ALLOWED THE CONTRACTOR AS A RESULT.

 13. STRUCTURAL STEEL CONNECTIONS SHALL BE MADE USING 7/8" DIAMETER HIGH STRENGTH BOLTS IN ACCORDANCE WITH AASHO SPECIFICATIONS ART. 2.10.20 WITH AMENDMENTS TRENGTH.
- THERETO.

 14. SEE SPECIAL PROVISIONS FOR WELDED STRUCTURES.
- * Reinforcing bars 145 and 185 shall conform to ASTM Specification 408 and shall be furnished full length. If the Contractor prefers any other method, he shall submit sketches and method for splicing these bars to the Highway Department for approval.

 No lap splices will be allowed.

BRIDGE NO. 56G

STATE OF TENNESSEE
DEPARTMENT OF HIGHWAYS AND PUBLIC WORKS
INTERSTATE HIGHWAY SYSTEM
MEMPHIS AND SHELBY COUNTY

HARLAND BARTHOLOMEW AND ASSOCIATES
AND
CLARK, DAILY AND DIETZ

Ton. 1963 RGB JNIN GN MFT None

N. B. U. S. 61 OVER NONCONNAH CREEK
GENERAL NOTES & QUANTITIES

Bridge Dwg. 2 of 13

MIGRATIL


K-30-43


LEGEND


U Vertical Pile

Botter Pile (3:12)


Test Pile (40' long)

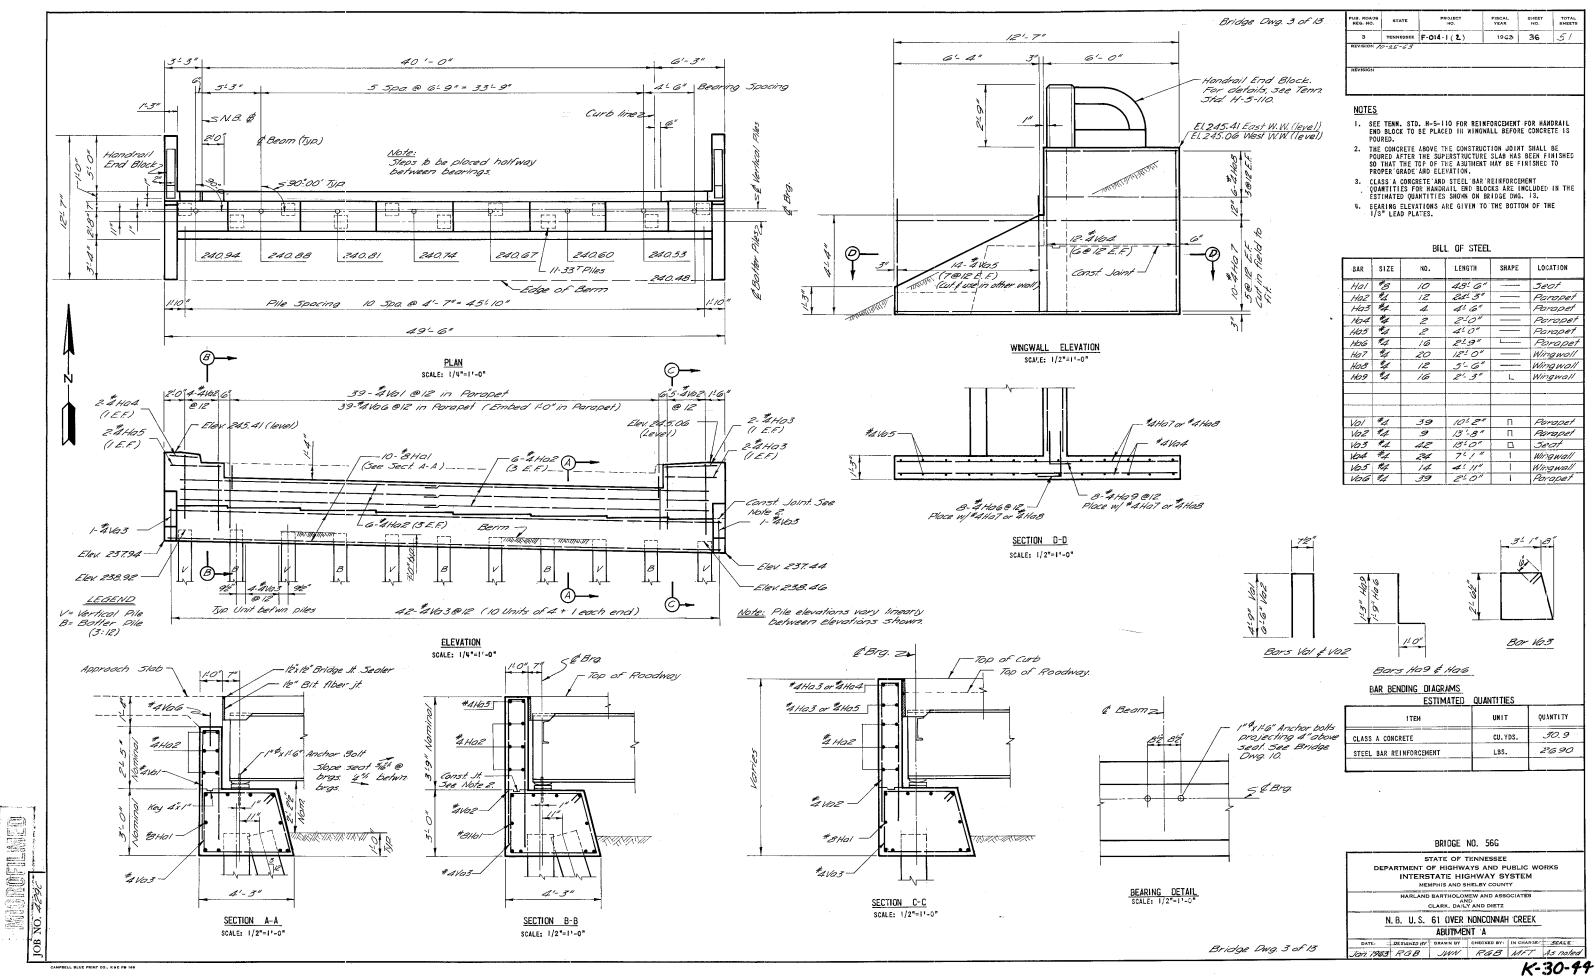


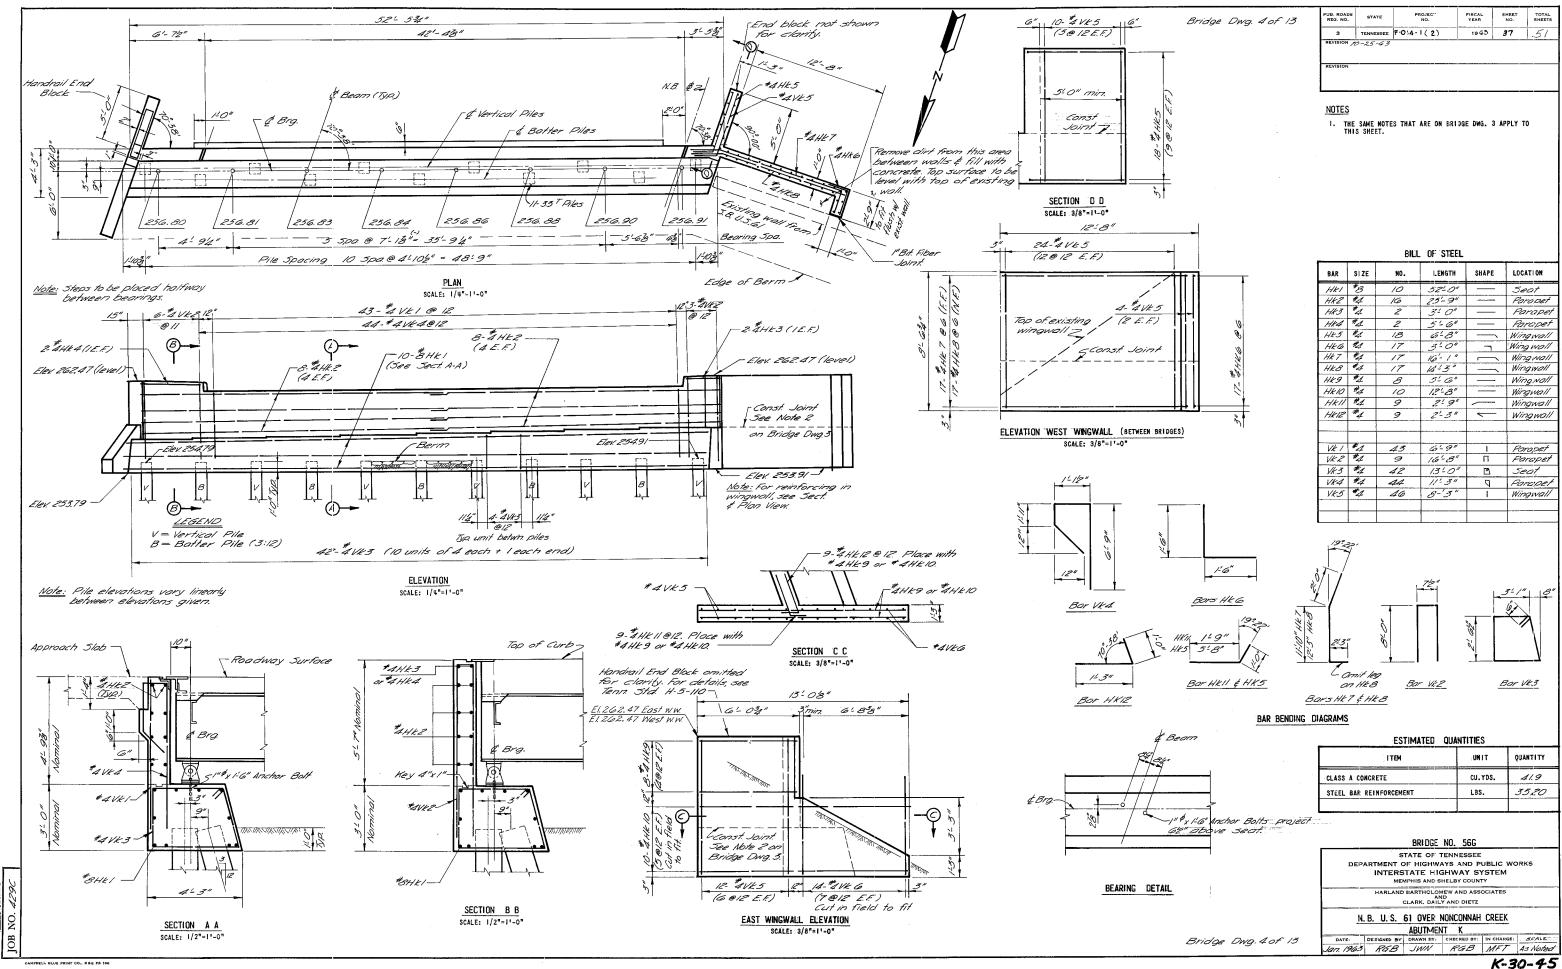

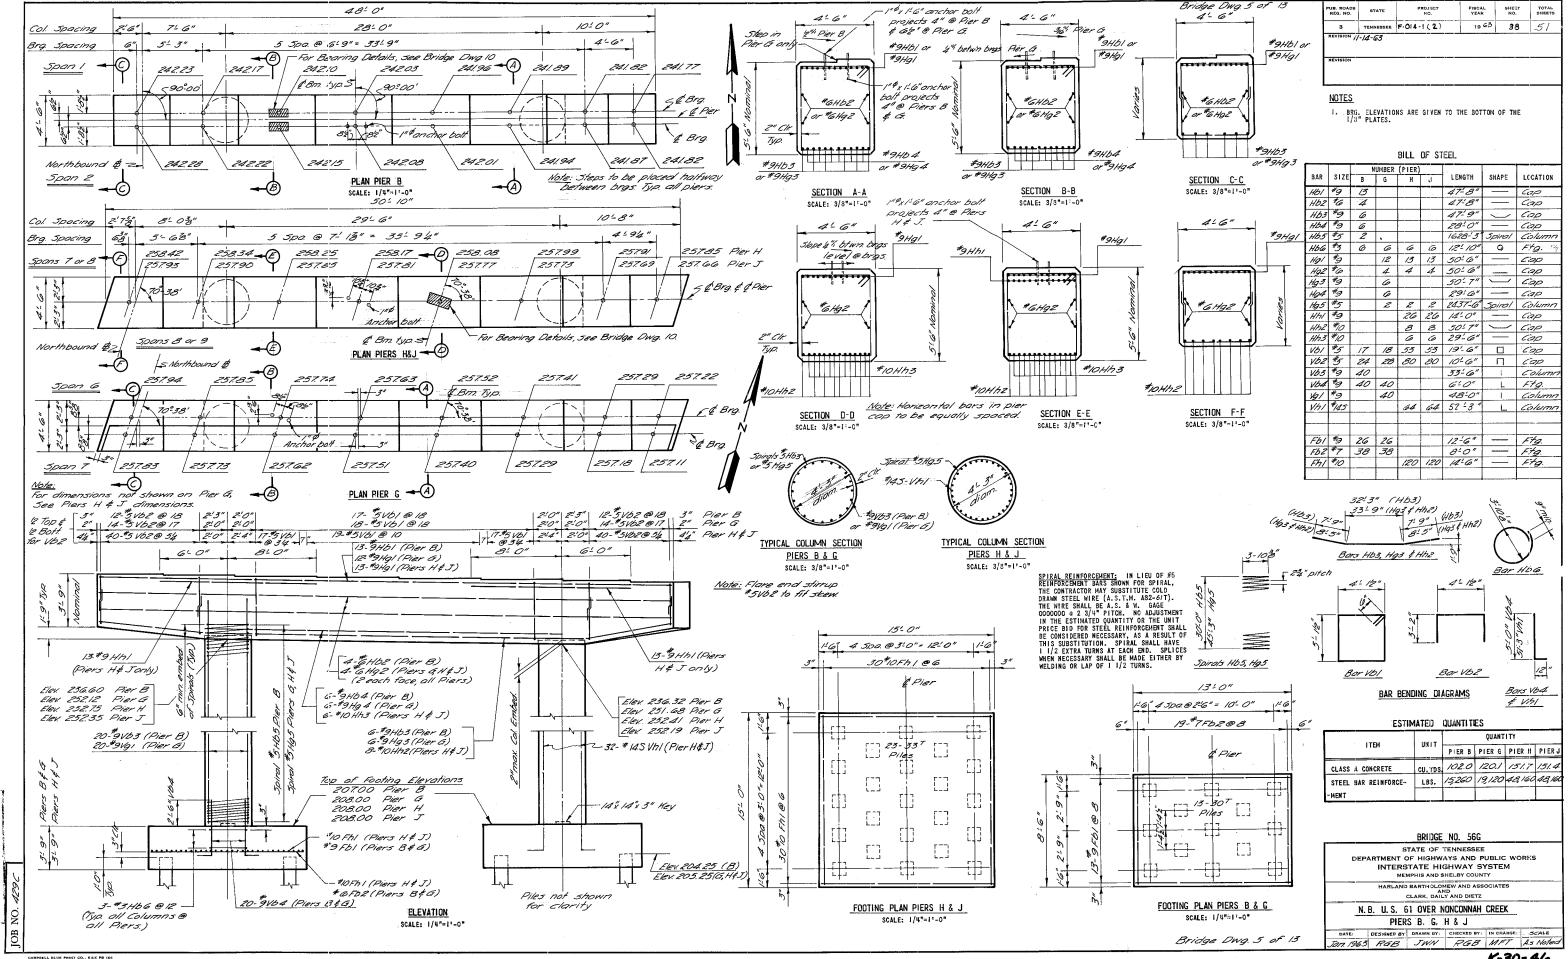

BIICHOFIL MED

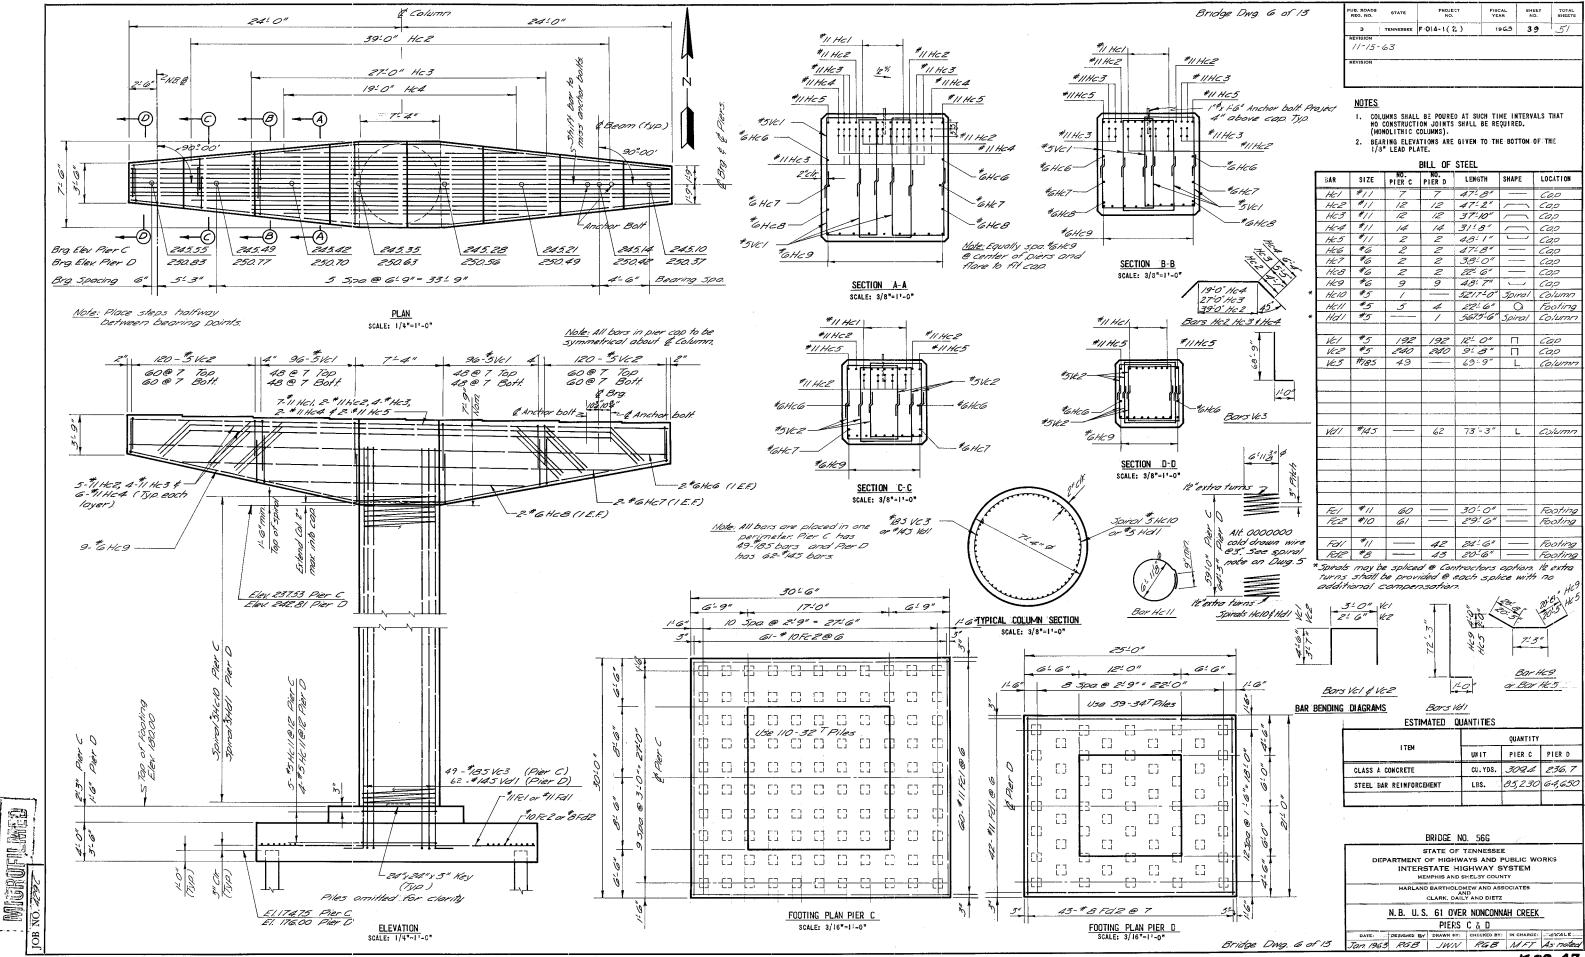

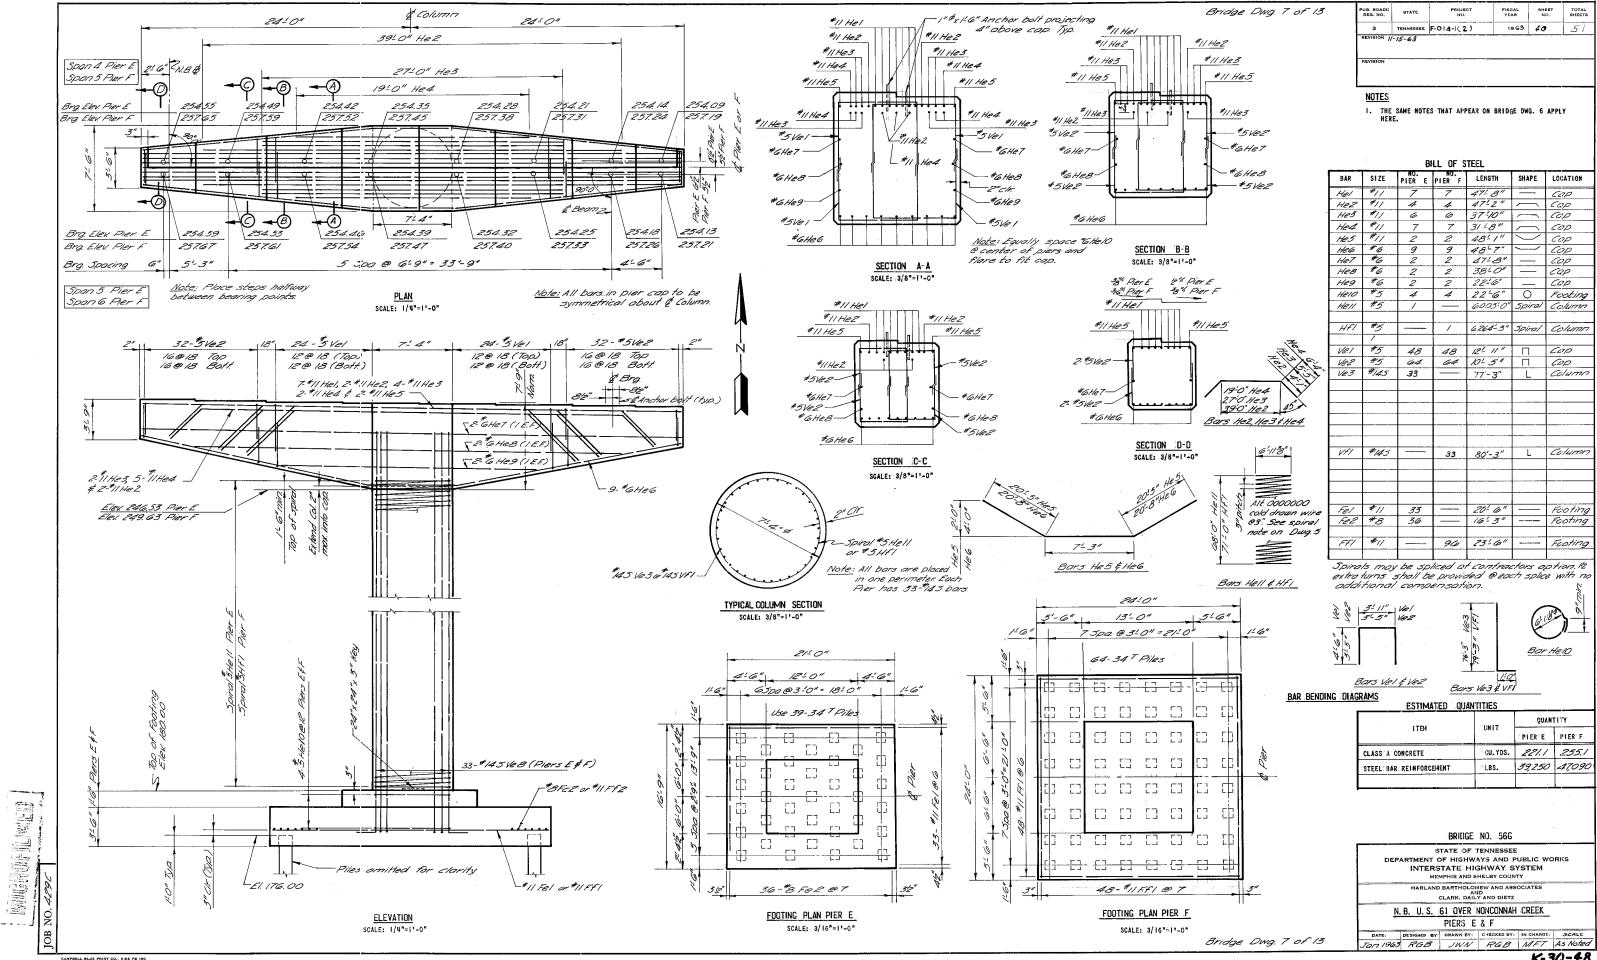

K-30-48

